

PROJECT:
PROPOSED PROVISIONING CENTER

LOCATION:
1105 W CHISHOLM ST. ALPENA, MI 49707

DRAWING INDEX	
SHEET No.	SHEET TITLE
SP-1	TOPO SURVEY / EXISTING SITE PLAN (COVER SHEET)
SP-2	PROPOSED SITE PLAN
SP-3	LANDSCAPE PLAN
SP-4	PHOTOMETRIC LIGHTING PLAN
A-1	EXISTING / DEMO FLOOR PLAN
A-2	PROPOSED FLOOR PLAN
A-3	BUILDING ELEVATIONS

Map Unit Description: Urbanland-Udipsammnts, deep water table complex, 0 to 3 percent slopes—Alpena County, Michigan

Alpena County, Michigan

376A—Urbanland-Udipsammnts, deep water table complex, 0 to 3 percent slopes

Map Unit Setting

National map unit symbol: 8119

Elevation: 580 to 1,110 feet

Mean annual precipitation: 27 to 32 inches

Mean annual air temperature: 43 to 46 degrees F

Frost-free period: 95 to 140 days

Farmstead classification: Not prime farmland

Map Unit Composition

Urban land: 65 percent

Udipsammnts, deep water table, and similar soils: 30 percent

Minor components: 5 percent

Estimates are based on observations, descriptions, and transects of the mapunit.

Description of Urban Land

Setting

Landform: Lake plains

Landform position (three-dimensional): Rise

Down-slope shape: Linear

Across-slope shape: Linear

Description of Udipsammnts, Deep Water Table

Setting

Landform: Lake plains

Landform position (three-dimensional): Rise

Down-slope shape: Linear

Across-slope shape: Linear

Parent material: Sandy material

Typical profile

A-0 to 4 inches: fine sand

C1-4 to 42 inches: sand

C2-42 to 60 inches: sand

Properties and qualities

Slope: 0 to 2 percent

Depth to restrictive feature: More than 80 inches

Drainage class: Well drained

Capacity of the most limiting layer to transmit water (Ksat): High to very high (5.95 to 19.98 in/hr)

Depth to water table: About 42 inches

Frequency of flooding: None

Frequency of ponding: None

Calcium carbonate, maximum content: 25 percent

Natural Resources Conservation Service

Soil Survey

National Cooperative Soil Survey

5/10/2022

Page 1 of 2

Map Unit Description: Urbanland-Udipsammnts, deep water table complex, 0 to 3 percent slopes—Alpena County, Michigan

Available water supply, 0 to 60 inches: Low (about 3.7 inches)

Interpretive groups

Land capability classification (irrigated): None specified

Hydrologic Soil Group: A

Ecological site: F094CY031M1 - Cool Rich Sandy Drift

Hydric soil rating: No

Minor Components

Au gres

Percent of map unit: 3 percent

Landform: Lake plains

Landform position (three-dimensional): Rise

Down-slope shape: Linear

Across-slope shape: Linear

Hydric soil rating: No

Taxes

Percent of map unit: 2 percent

Landform: Depressions on lake plains

Landform position (three-dimensional): Dip

Down-slope shape: Linear

Across-slope shape: Linear

Hydric soil rating: Yes

Data Source Information

Soil Survey Area: Alpena County, Michigan

Survey Area Date: Version 17, Aug 31, 2021



Natural Resources Conservation Service

Soil Survey

National Cooperative Soil Survey

5/10/2022

Page 1 of 2

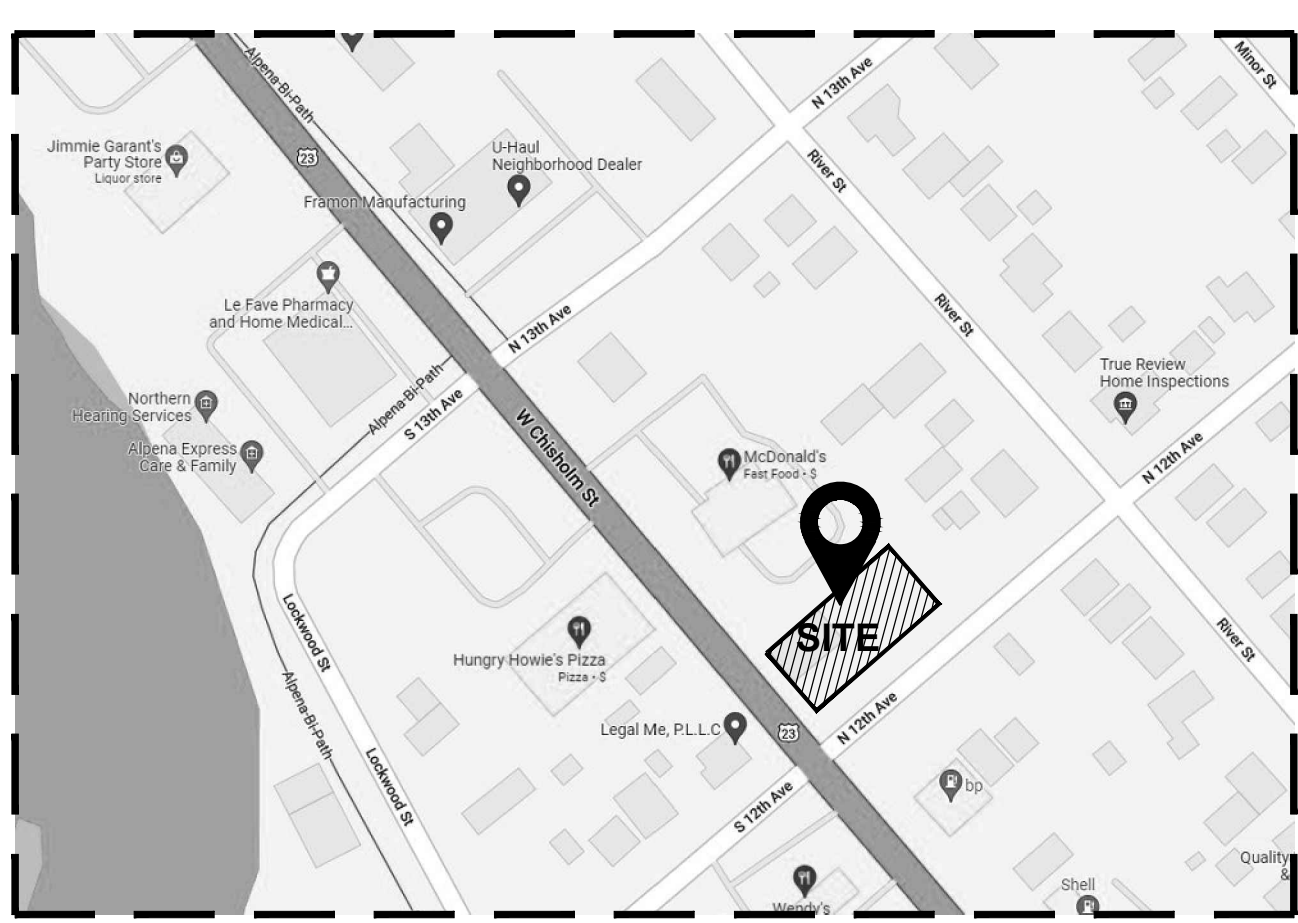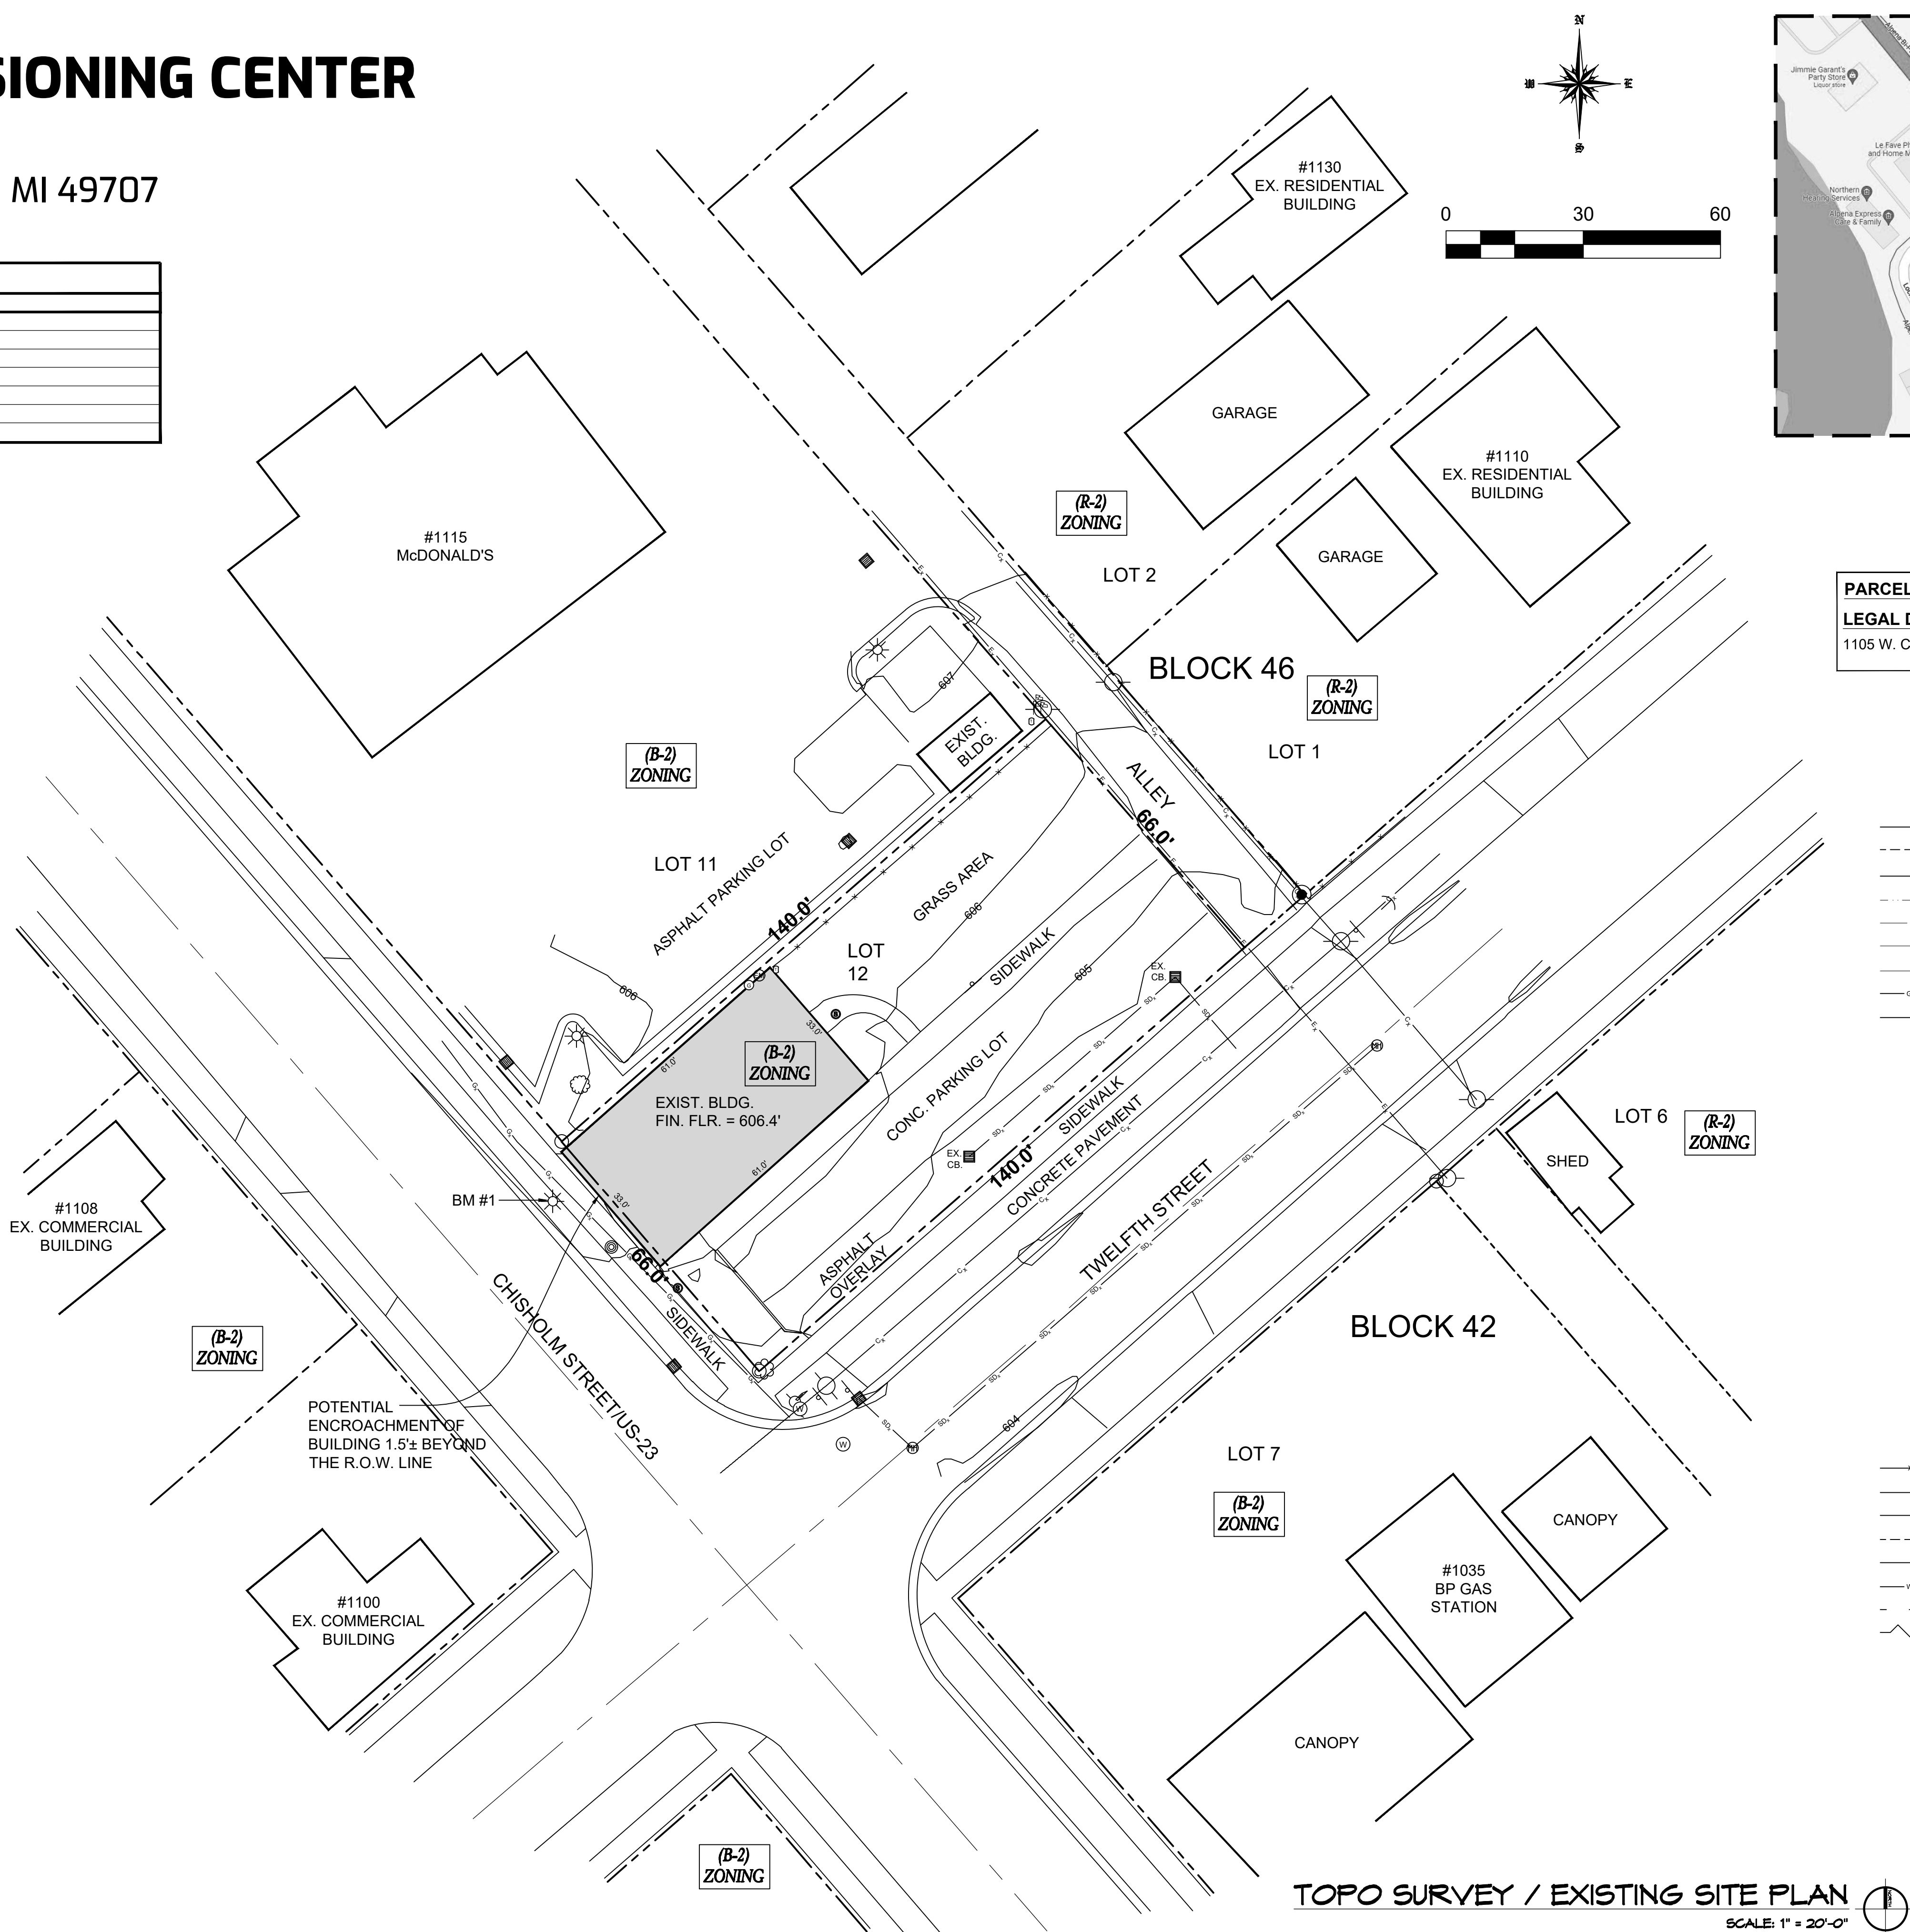

LOCATION MAP
N.T.S.

PARCEL ID: 093-637-000-865-00

LEGAL DESCRIPTION:
1105 W. CHISHOLM ST. LOT 12 BLK 46 OF THE VILLAGE NOW CITY

- LEGEND
- EXISTING PAVEMENT
 - EXISTING GRAVEL
 - EXISTING BACK OF CURB
 - EXISTING TOP OF BANK
 - EXISTING BOTTOM OF BANK
 - EXISTING OVERHEAD POWER PRIMARY
 - EXISTING OVERHEAD POWER SECONDARY
 - UNDERGROUND GAS LINE
 - EXISTING OVERHEAD COMMUNICATION LINE
 - FIRE HYDRANT
 - CATCH BASIN
 - MAN HOLE
 - SANITARY CLEANOUT
 - ELECTRIC METER
 - WATER VALVE
 - GAS VALVE/METER
 - WATER SHUTOFF
 - POWER POLE
 - TELEPHONE ACCESS
 - TELEPHONE PEDESTAL
 - LIGHT POLE
 - GUY ANCHOR
 - SIGN
 - LARGE SIGN
 - POST
 - STRUCTURAL SUPPORT
 - MAILBOX
 - FENCE
 - SANITARY SEWER
 - STORM SEWER
 - SIDEWALK WITH PAVERS
 - SIDEWALK
 - WATER LINE
 - TREE LINE
 - BRUSH/BUSH LINE
 - DECIDUOUS TREE
 - PINE TREE
 - BUSH

BM #1 - ELEV. = 605.26

NWL'Y BOLT ON LIGHT POLE BASE

AT THE NW CORNER OF LOT 12

HORIZONTAL DATUM IS MICHIGAN STATE PLANE
CENTRAL ZONE UTILIZING THE MDOT CORS

VERTICAL DATUM IS NAVD88 UTILIZING THE MDOT CORS

MA ARCHMASTER
Residential & Commercial Designs

Cell Phone: (313) 505-7744
Email: alahwalmoneer@gmail.com

VIVID
DESIGN STUDIO

PROJECT:
PROPOSED PROVISIONING CENTER

ADDRESS:
1105 W CHISHOLM ST. ALPENA, MI 49707

CLIENT'S NAME: Fadi Yousif & Mark Yousif

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REVISIONS:

05/25/2022
06/06/2022

DATE: 05/11/2022

DRAWN BY: MONEER ALAHWAL

SCALE: AS NOTED






SHEET TITLE:
TOPO SURVEY / EXISTING SITE PLAN

COVER SHEET

SHEET #:
SP-1

APPROVED BY:

TAHA M. KHALAFF
ENGINEER
No. 63348
LICENSED PROFESSIONAL ENGINEER

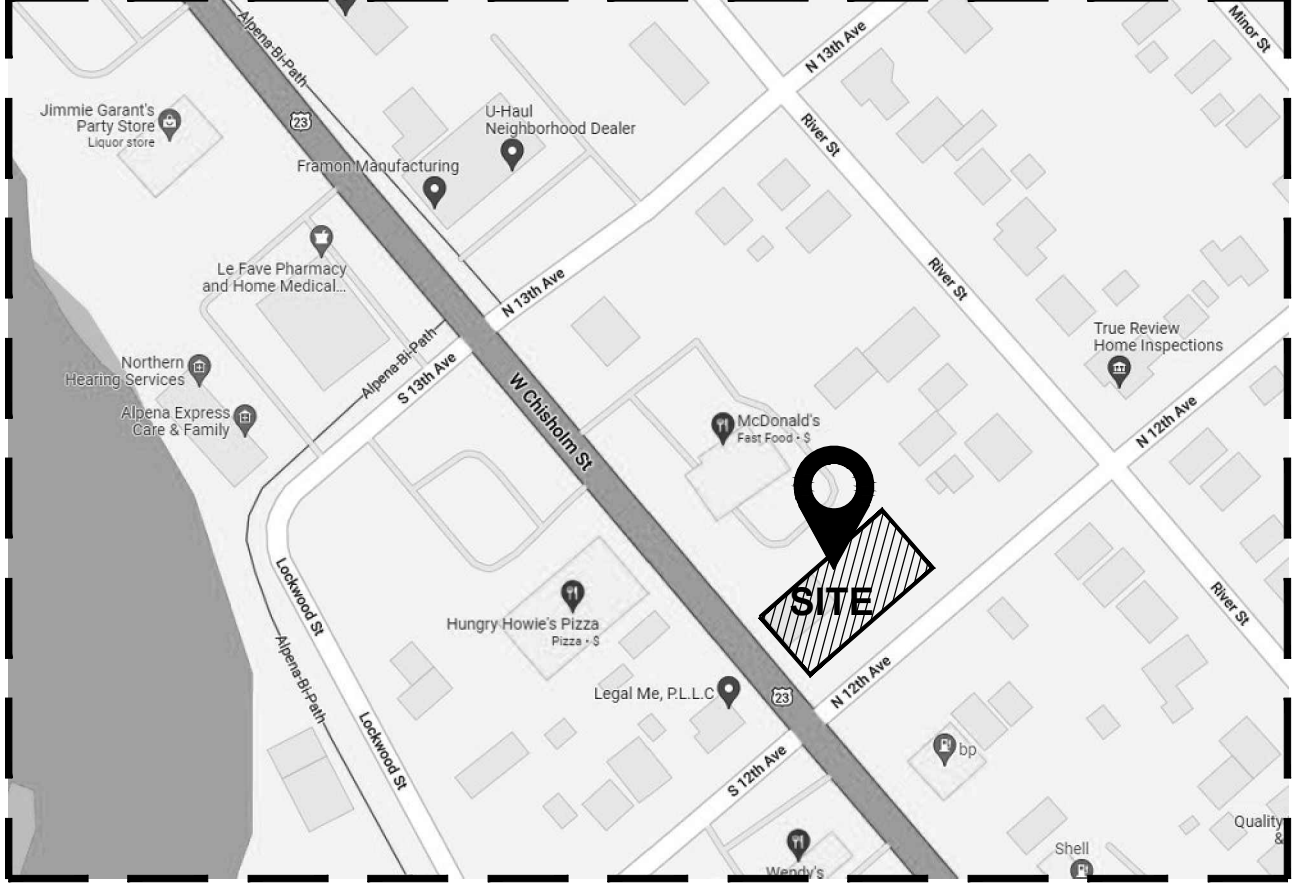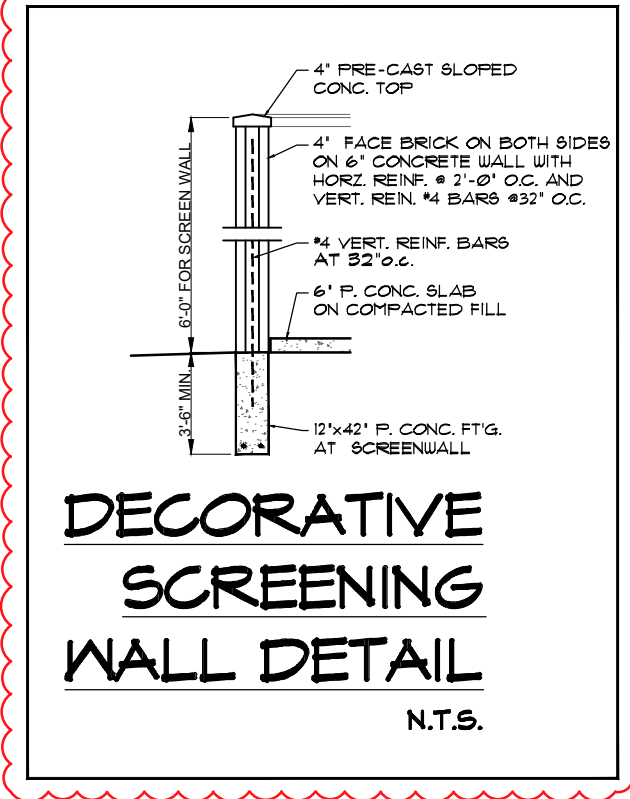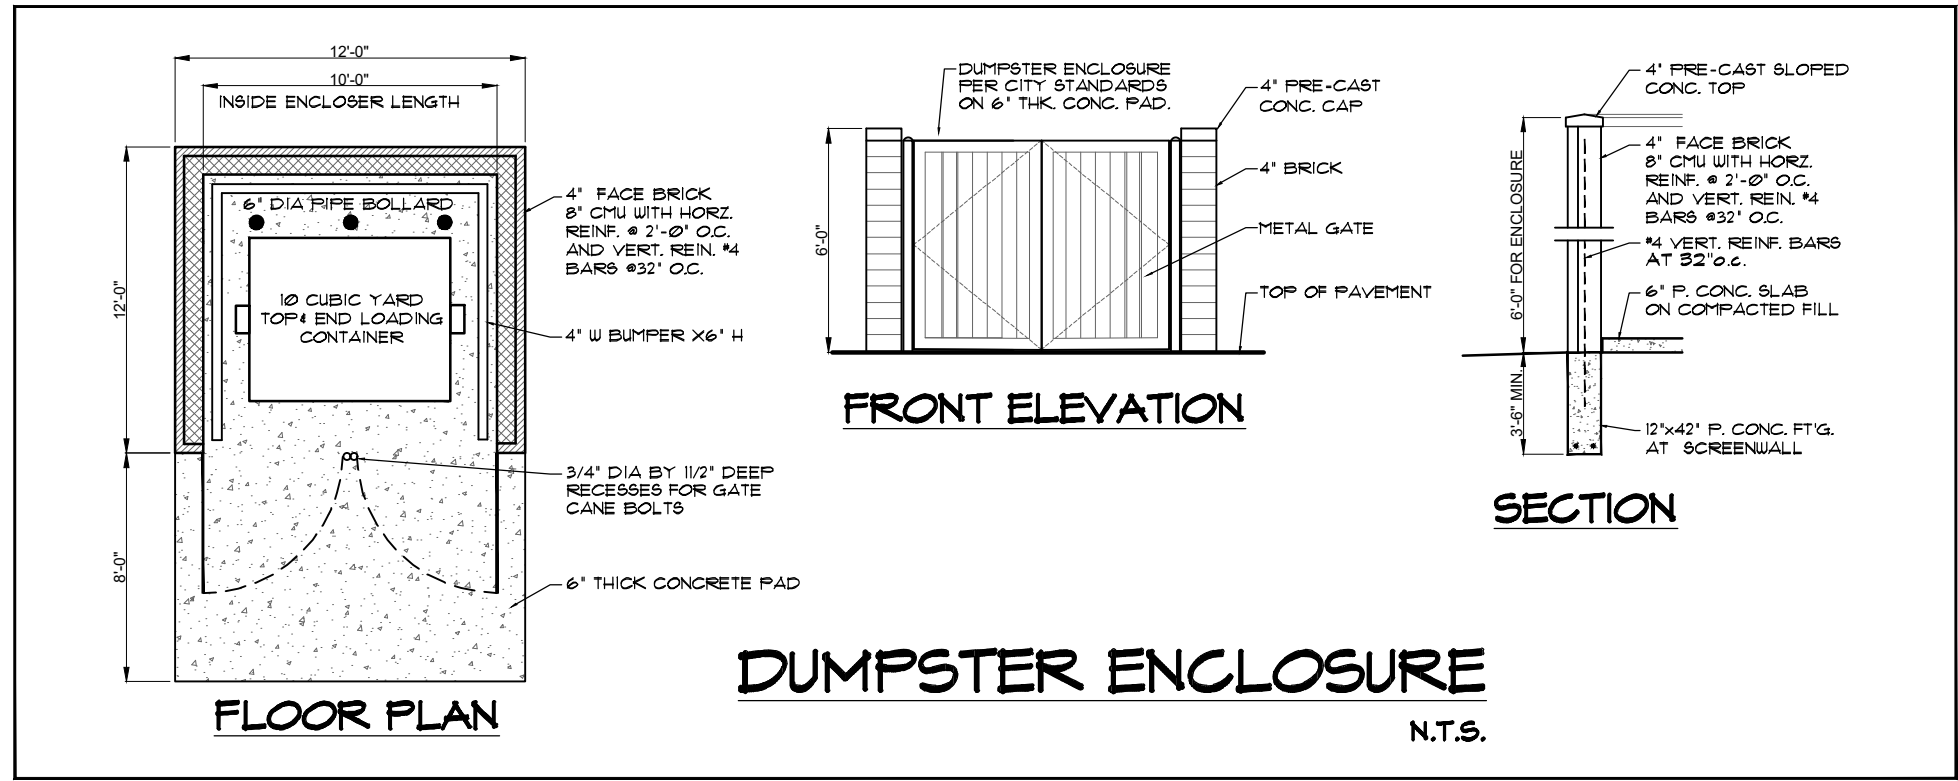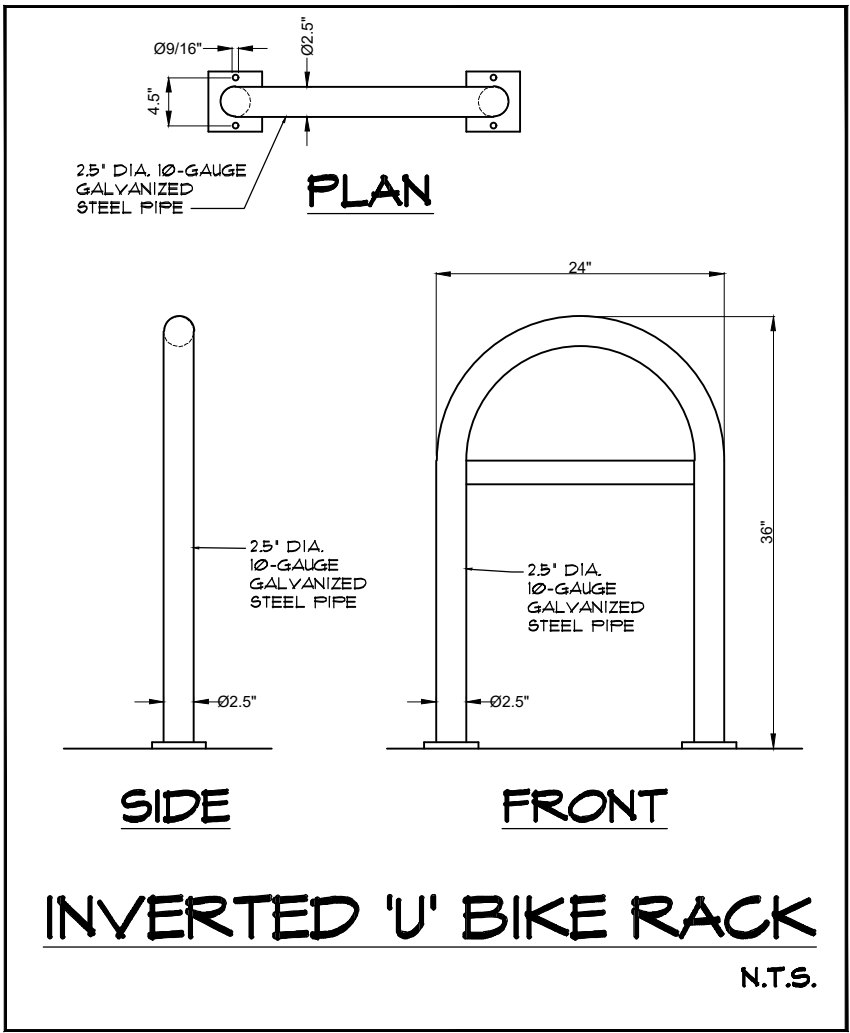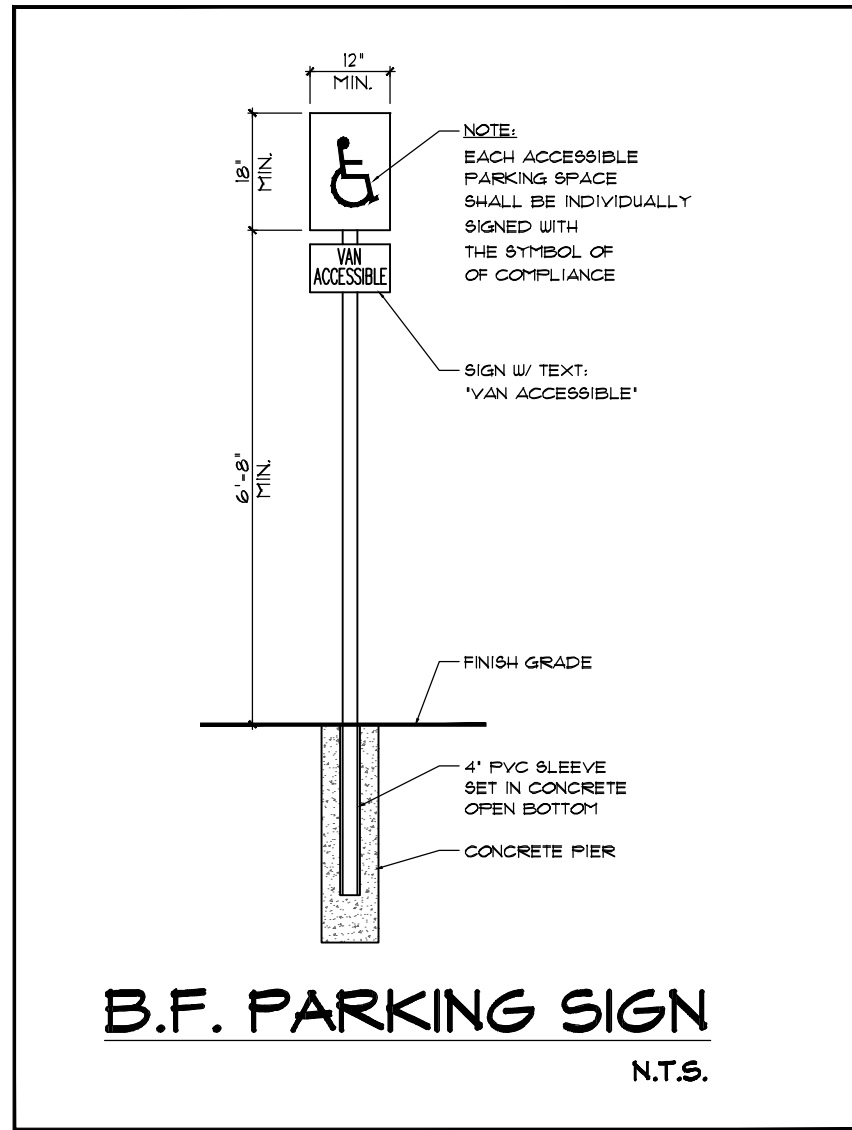

LOCATION MAP
N.T.S.





PARCEL ID: 093-637-000-865-00
LEGAL DESCRIPTION:
1105 W. CHISHOLM ST. LOT 12 BLK 46 OF THE VILLAGE NOW CITY

ALL SIGNAGE WILL REQUIRE SEPARATE SUBMITTALS AND PERMITS.
(SEE PROPOSED SIGN ON BUILDING)

GOVERNING CODE: MICHIGAN BUILDING CODE 2015 AND CITY OF ALPENA, MI ZONING ORDINANCE	
USE GROUP :	M (MERCANTILE)
PROPOSED USE:	PROVISIONING CENTER
AREA OF THE PROPERTY:	9,240 SQ. FT. (0.212 ACRES)
ZONING	B-2 (GENERAL BUSINESS)
BUILDING DATA: EXISTING BUILDING AREA = 2,000 SQ. FT. EXISTING BUILDING HEIGHT = 13.0 FT.	
LOT COVERAGE	EXISTING = 21.64%
PARKING REQUIREMENTS FOR PROVISIONING CENTER REQUIRED PARKING SPACES: FOR RETAIL SALES: 1 SPACE PER 400 SQUARE FEET 2,000/400 = 5 PARKING SPACES REQUIRED	
PROVIDED PARKING SPACES: 5 PARKING SPACES INCL. 1 H.C. PARKING SPACE	
BICYCLE PARKING SPACES: 4 BICYCLE SPACES ARE PROVIDED	
OPERATING HOURS MON - SUN 9:00 AM - 8:00 PM	
CODES CURRENTLY IN EFFECT - 2015 MICHIGAN BUILDING CODE, MBC 2015 - 2015 MICHIGAN MECHANICAL CODE MMC 2015 - 2015 MICHIGAN PLUMBING CODE, MPC 2015 - 2017 NATIONAL ELECTRICAL CODE, 2017 CONSTRUCTION CODE - PART 8. ELECTRICAL CODE RULES - ACCESSIBILITY: MICHIGAN BARRIER FREE DESIGN LAW, P.A. 1966 AS AMENDED AND THE 2009 ICC/ANSI A117.1 STANDARD AS REFERENCED FROM CHAPTER 11 OF THE 2015 MICHIGAN BUILDING CODE.	

LOADING AND UNLOADING NOTES:
- LOADING AND UNLOADING WILL BE AT THE SPECIFIED 'NO-PARKING' AREA.
- LOADING AND UNLOADING SHALL BE OUT OF OPERATION HOURS.

INFORMATION MAY BE REQUIRED:
OWNER/APPLICANT TO PROVIDE THE FOLLOWS:
- ECONOMIC BENEFITS TO REAL PROPERTY
- PHYSICAL IMPROVEMENTS TO BUILDING EXTERIOR
- MAINTENANCE PLAN
- ARTICLE 3 SECTION 3.33.C ODOR MITIGATION PLAN

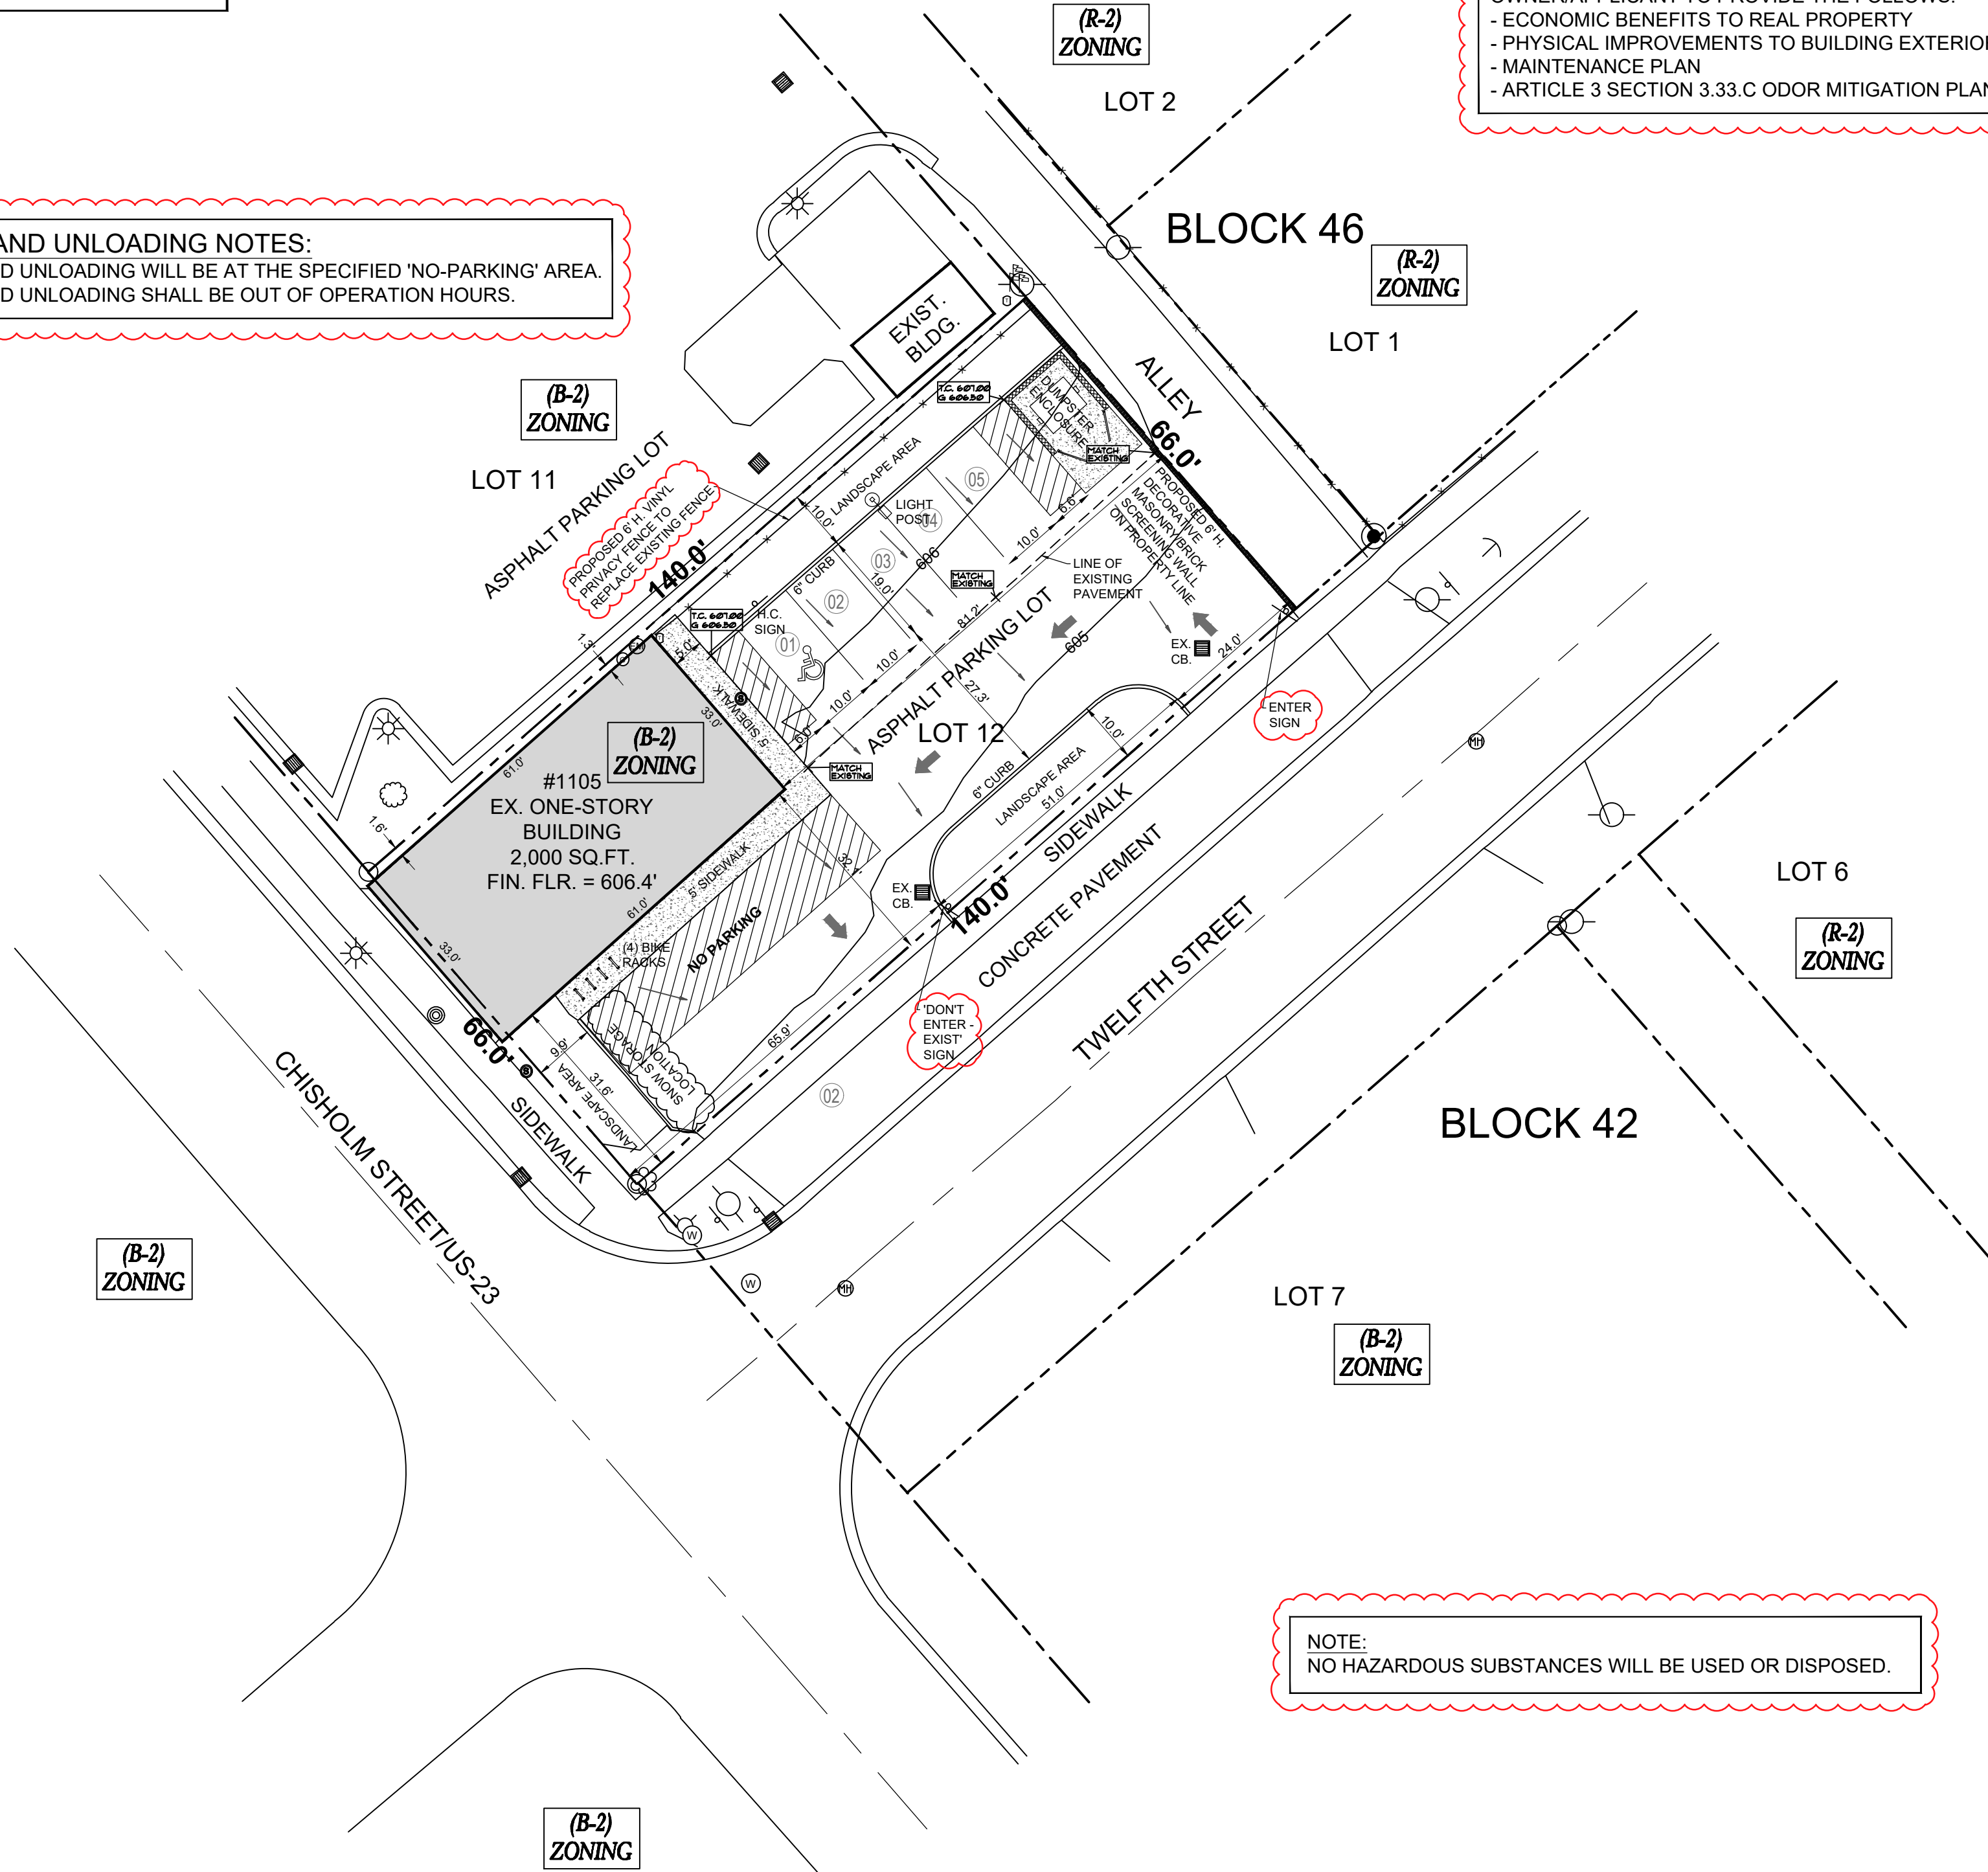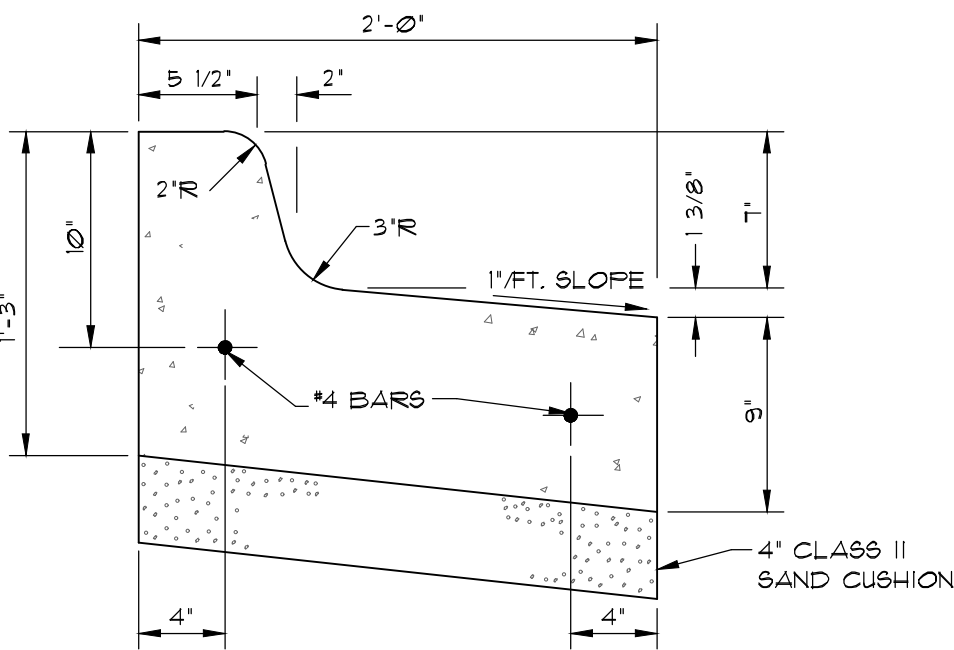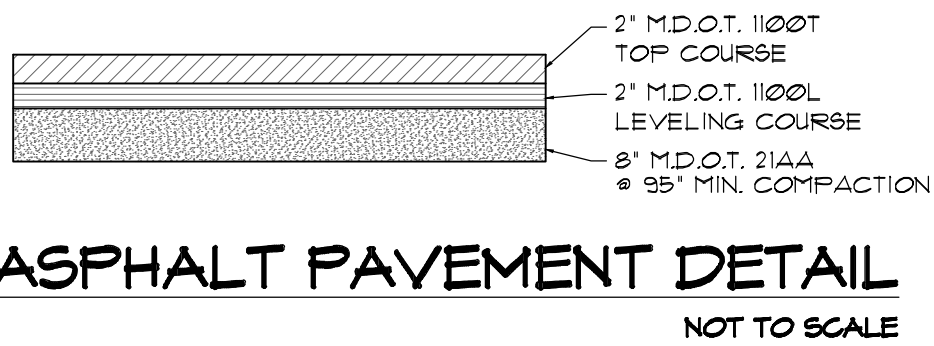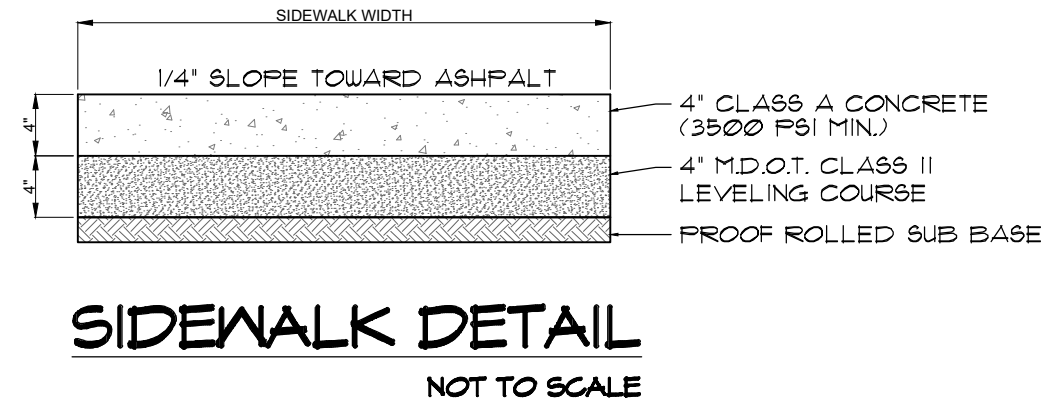

NOTE:
NO HAZARDOUS SUBSTANCES WILL BE USED OR DISPOSED.



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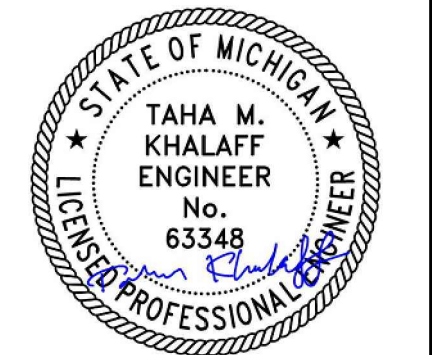
REVISIONS:	
_____	05/25/2022
_____	06/06/2022

DATE:	05/11/2022
DRAWN BY:	MONIEER ALAHWAL
SCALE:	AS NOTED

SHEET TITLE:
- PROPOSED SITE PLAN

SHEET #:
SP-2

APPROVED BY:




GENERAL STANDARDS:



- ALL AREAS NOT COVERED BY BUILDINGS, PARKING AREAS, DRIVENWAYS, WALKWAYS, PEDESTRIAN PLAZAS OR OTHER PEDESTRIAN-ORIENTED IMPERVIOUS SURFACES OR WATER SURFACES SHALL BE PLANTED WITH LIVING VEGETATION, INCLUDING CANOPY TREES, SHRUBBERY AND GROUND COVERS. THE COMBINATION OF PLANT MATERIALS SELECTED SHALL BE PLACED IN HARMONIOUS AND NATURAL ASSOCIATIONS AND REPRESENT THE APPROVED INDIGENOUS LANDSCAPE MATERIALS LISTED IN SUBSECTION H.
- NOT LESS THAN TWENTY (20) PERCENT OF ANY LANDSCAPE AREA SHALL BE COVERED BY TREES, SHRUBS AND GROUND COVER IN COMBINATION. A COMBINATION OF STONE AND OTHER MULCHES, GRASS AND OTHER GROUND COVERS, PEDESTRIAN WALKS, OTHER IMPERVIOUS SURFACES OR WATER SURFACES MAY COVER THE REMAINING EIGHTY (80) PERCENT OF THE LANDSCAPE AREA. AREAS USED FOR STORM DRAINAGE PURPOSES, SUCH AS UNFENCED DRAINAGE COURSES OR RETENTION AREAS IN FRONT OR SIDE YARDS, MAY BE PART OF THIS EIGHT (80) PERCENT. WITHIN A FRONT AND CORNER SIDE YARD, THE FOLLOWING SHALL APPLY TO THE TWENTY (20) PERCENT TREE, SHRUB, AND GROUND COVER COMBINATION AREA:
 - AT LEAST ONE (1) CANOPY OR ORNAMENTAL TREE PER FOUR THOUSAND (4,000) SQUARE FEET OF YARD AREA FOR THE FIRST TWENTY-FOUR THOUSAND (24,000) SQUARE FEET; AND
 - ONE ADDITIONAL CANOPY OR ORNAMENTAL TREE PER SIX THOUSAND (6,000) SQUARE FEET OF YARD AREA ABOVE TWENTY-FOUR THOUSAND (24,000) SQUARE FEET.
- THE GENERAL SITE TOPOGRAPHY AND ANY NATURAL LANDFORMS UNIQUE TO THE PROPERTY SHALL BE MAINTAINED AND MADE PART OF THE DEVELOPMENT WHENEVER POSSIBLE TO REINFORCE THE LOCAL AND REGIONAL CHARACTER.
- THE SUBSTITUTION OF NATURAL VEGETATION IN LIEU OF LANDSCAPING MAY BE APPROVED ON A CASE BY CASE BASIS.
- ALL TREES SHALL BE LOCATED TO ALLOW SUFFICIENT ROOM FOR GROWTH.
- THE REQUIRED LANDSCAPING SHALL BE PLANTED WITH PERMANENT LIVING PLANT MATERIALS WITHIN THIRTY (30) DAYS FROM THE DATE OF OCCUPANCY AND SHALL THEREAFTER BE MAINTAINED IN PRESENTABLE CONDITION, AND SHALL BE KEPT FREE FROM REFUSE AND DEBRIS; PROVIDED FURTHER THAT ALL PLANT MATERIALS SHALL BE CONTINUOUSLY MAINTAINED IN A SOUND, HEALTHY AND VIGOROUS GROWING CONDITION, AND SHALL BE KEPT FREE OF PLANT DISEASES AND INSECT PESTS. ALL UNHEALTHY AND DEAD MATERIAL SHALL BE REPLACED WITHIN ONE (1) YEAR OF DAMAGE OR DEATH OR THE NEXT APPROPRIATE PLANTING PERIOD, WHICHEVER COMES FIRST. ALL LANDSCAPED AREAS SHALL BE PROVIDED WITH A READILY AVAILABLE AND ACCEPTABLE WATER SUPPLY. THE ZONING ADMINISTRATOR MAY EXTEND THE TIME PERIOD FOR PLANTING WHEN SEASONAL CONDITIONS ARE SUCH THAT PLANTING CANNOT BE UNDERTAKEN.

MINIMUM LANDSCAPE MATERIAL STANDARDS:

- ALL PLANT MATERIAL SHALL BE HEALTHY, FREE OF DISEASE AND INSECTS, COMPATIBLE WITH LOCAL CLIMATE, SITE SOILS, DRAINAGE, HAVE AVAILABLE WATER SUPPLY, AND MEET THE CURRENT AMERICAN ASSOCIATION OF NURSERYMEN STANDARDS.
- ALL LANDSCAPE MATERIALS SHALL BE INSTALLED IN SUCH A MANNER SO AS NOT TO ALTER DRAINAGE PATTERNS ON SITE OR ADJACENT PROPERTIES OR OBSTRUCT VISION FOR REASONS OF SAFETY, INGRESS OR EGRESS.
- ALL PLANT MATERIAL SHALL BE PLANTED IN A MANNER SO AS NOT TO OBSTRUCT ACCESS TO OR VIEW OF FIRE HYDRANTS OR OTHER FIRE CONNECTIONS, NOT INTERFERE WITH UTILITY LINES (ABOVE AND BELOW GROUND) AND PUBLIC ROADWAYS. LANDSCAPE MATERIALS SHALL NOT CONSTITUTE A NUISANCE TO NEIGHBORING PROPERTIES.
- EXISTING PLANT MATERIAL, WHICH COMPLIES WITH THE STANDARDS AND INTENT OF THE ORDINANCE, AS DETERMINED BY THE PLANNING DIRECTOR OR ZONING ADMINISTRATOR, SHALL BE CREDITED TOWARD MEETING THE LANDSCAPE REQUIREMENTS.
- THE PLANT MATERIAL SHALL ACHIEVE ITS HORIZONTAL AND VERTICAL SCREENING EFFECT WITHIN FOUR (4) YEARS OF INITIAL INSTALLATION.
- THE OVERALL LANDSCAPE PLAN SHALL NOT CONTAIN MORE THAN THIRTY-THREE (33%) PERCENT OF ANY ONE PLANT SPECIES.

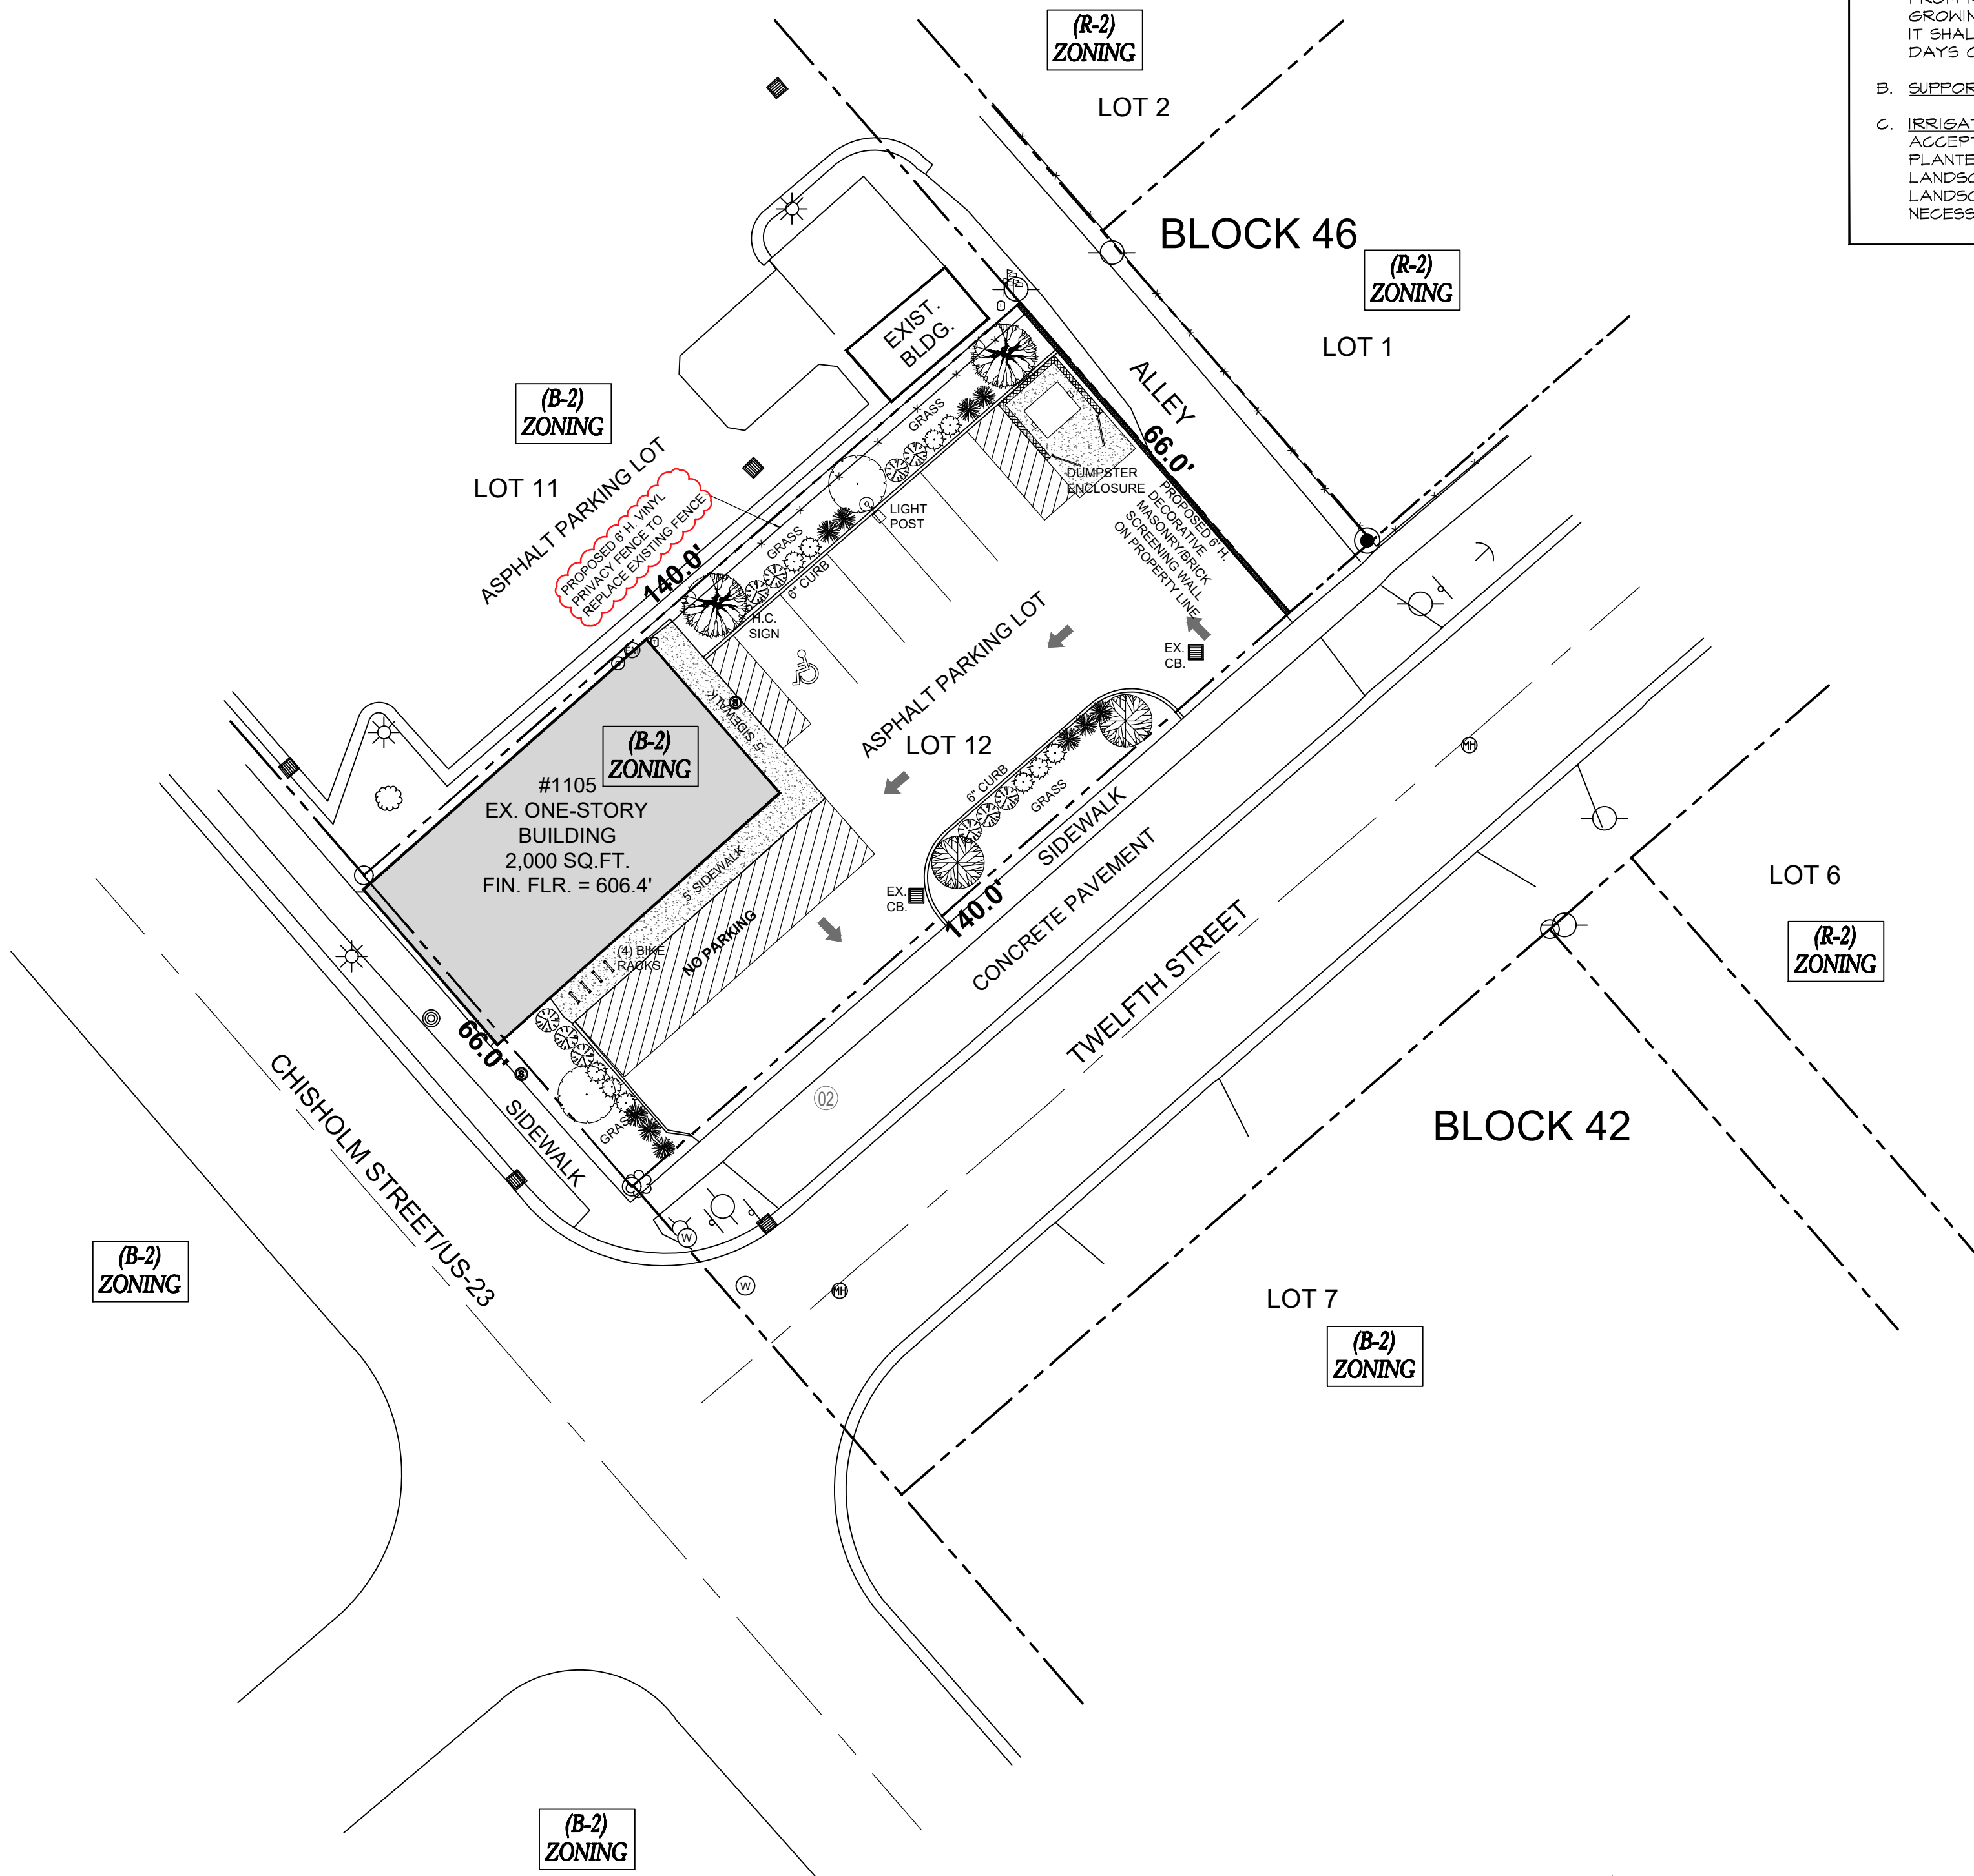

LANDSCAPE MATERIAL:					
	QUAN	MIN. SIZE	BOTANICAL NAME	COMMON NAME	SYMBOL
SHRUBS & BUSHES	8	2 FT. SPREAD	TAXUS X MEDIA 'WARDII'	WARD'S YEW	
	8	2 FT. SPREAD	BUDDLEJA DAVIDII	BUTTERFLY BUSH	
	8	2 FT. SPREAD	JUNIPERUS SCOPULORUM	GREY GLEAM JUNIPER	
DECIDUOUS/CANOPY TREES	2	2.5' DBH 6 FT. HEIGHT	NYSSA SYLVATICA	RED RAGE TUPELO	
	2	2.5' DBH 6 FT. HEIGHT	ACER RUBRUM	ARMSTRONG MAPLE	
	2	2.5' DBH 6 FT. HEIGHT	LIQUIDAMBAR STYRACIFLUA	AMERICAN SWEETGUM	
GENERAL REQUIREMENTS:					
A. CONDITIONS OF LANDSCAPING: LANDSCAPED AREAS AND PLANT MATERIALS SHALL BE KEPT FREE FROM REFUSE AND DEBRIS. PLANT MATERIALS, INCLUDING LAWNS, SHALL BE MAINTAINED IN A HEALTHY GROWING CONDITION, NEAT AND ORDERLY IN APPEARANCE. IF ANY PLANT DIES OR BECOMES DISEASED, IT SHALL BE REMOVED WITHIN 5 DAYS OF WRITTEN NOTICE FROM THE CITY AND REPLACED WITHIN 30 DAYS OR WITHIN AN EXTENDED TIME PERIOD AS SPECIFIED IN SAID NOTICE.					
B. SUPPORTS: TREE STAKES, GUY WIRES AND TREE WRAP SHALL BE REMOVED AFTER ONE YEAR.					
C. IRRIGATION: ALL LANDSCAPED AREAS SHALL BE PROVIDED WITH A READILY AVAILABLE AND ACCEPTABLE WATER SUPPLY, OR WITH AT LEAST ONE OUTLET LOCATED WITHIN 100 FEET OF ALL PLANTED MATERIAL TO BE MAINTAINED. THE PLANNING COMMISSION MAY REQUIRE FRONTAGE LANDSCAPING, BOULEVARD MEDIANS, INTERIOR PARKING LOT LANDSCAPING, AND OTHER CURBED LANDSCAPED AREAS TO BE IRRIGATED VIA AN UNDERGROUND SPRINKLER SYSTEM WHERE DEEMED NECESSARY.					

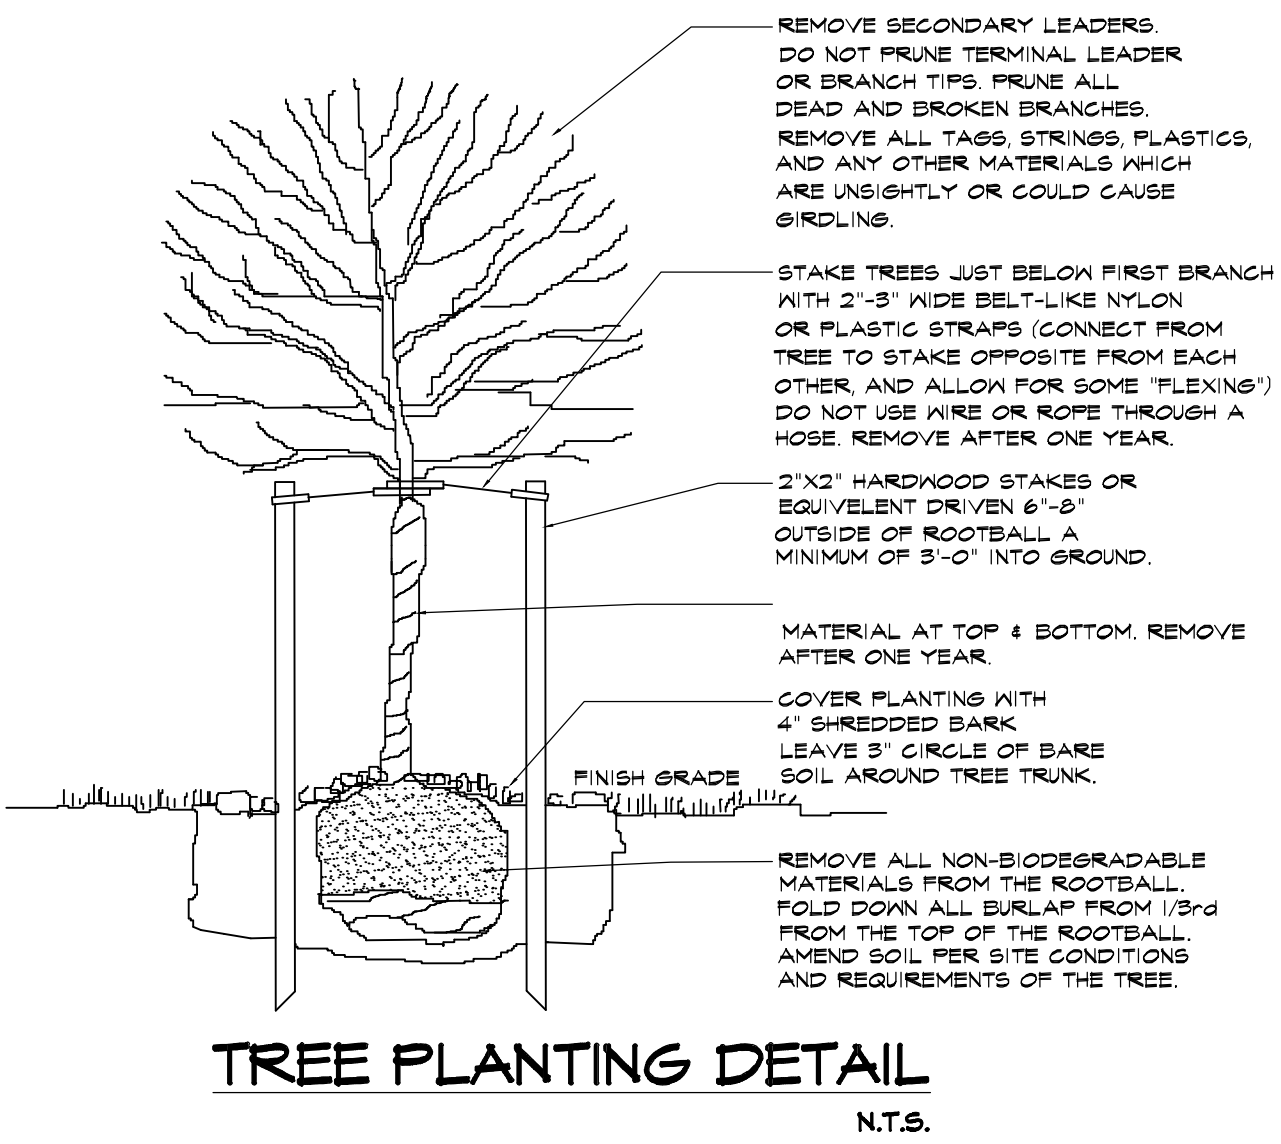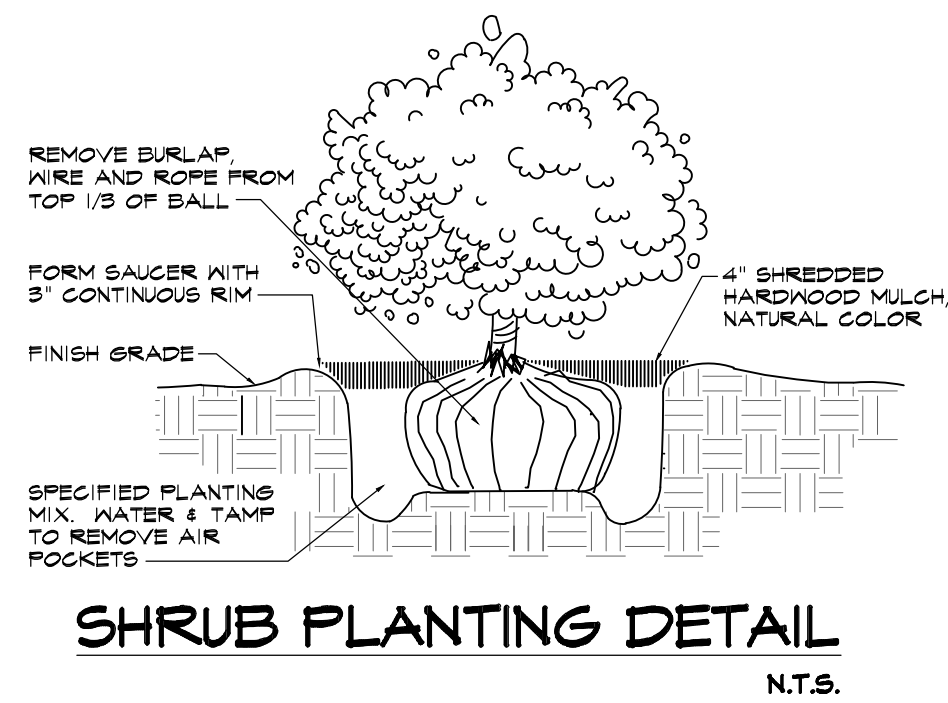

LANDSCAPE PLAN
SCALE: 1" = 20'-0"

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CLIENT'S NAME: Fadi Yousif & Mark Yousif

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REVISIONS:	
_____	05/25/2022
_____	06/06/2022

DATE: 05/11/2022

DRAWN BY: MONEER ALAHWAL

SCALE: AS NOTED

SHEET TITLE:
- LANDSCAPE PLAN

SHEET #:
SP-3


APPROVED BY:




Luminaire Schedule						
Symbol	Qty	Label	Arrangement	Total Lamp Lumens	LLF	Description
	3	WST LED P2 40K VF HVOLT	SINGLE	N.A.	1.000	WST LED P2 40K VF HVOLT
	1	KSF2 250S R2	SINGLE	30000	0.800	KSF2 250S R2

Luminaire Location Summary						
LumNo	Label	X	Y	Z	Orient	Tilt
1	WST LED P2 40K VF HVOLT	117.324	188.18	8	45	0
2	WST LED P2 40K VF HVOLT	115.592	171.924	8	315	0
3	WST LED P2 40K VF HVOLT	92.018	151.029	8	315	0
4	KSF2 250S R2	138.255	226.256	25	315	0

Calculation Summary						
Label	CalcType	Units	Avg	Max	Min	Avg/Min
CalcPts_1	Illuminance	Fc	1.12	15.9	0.0	N.A.

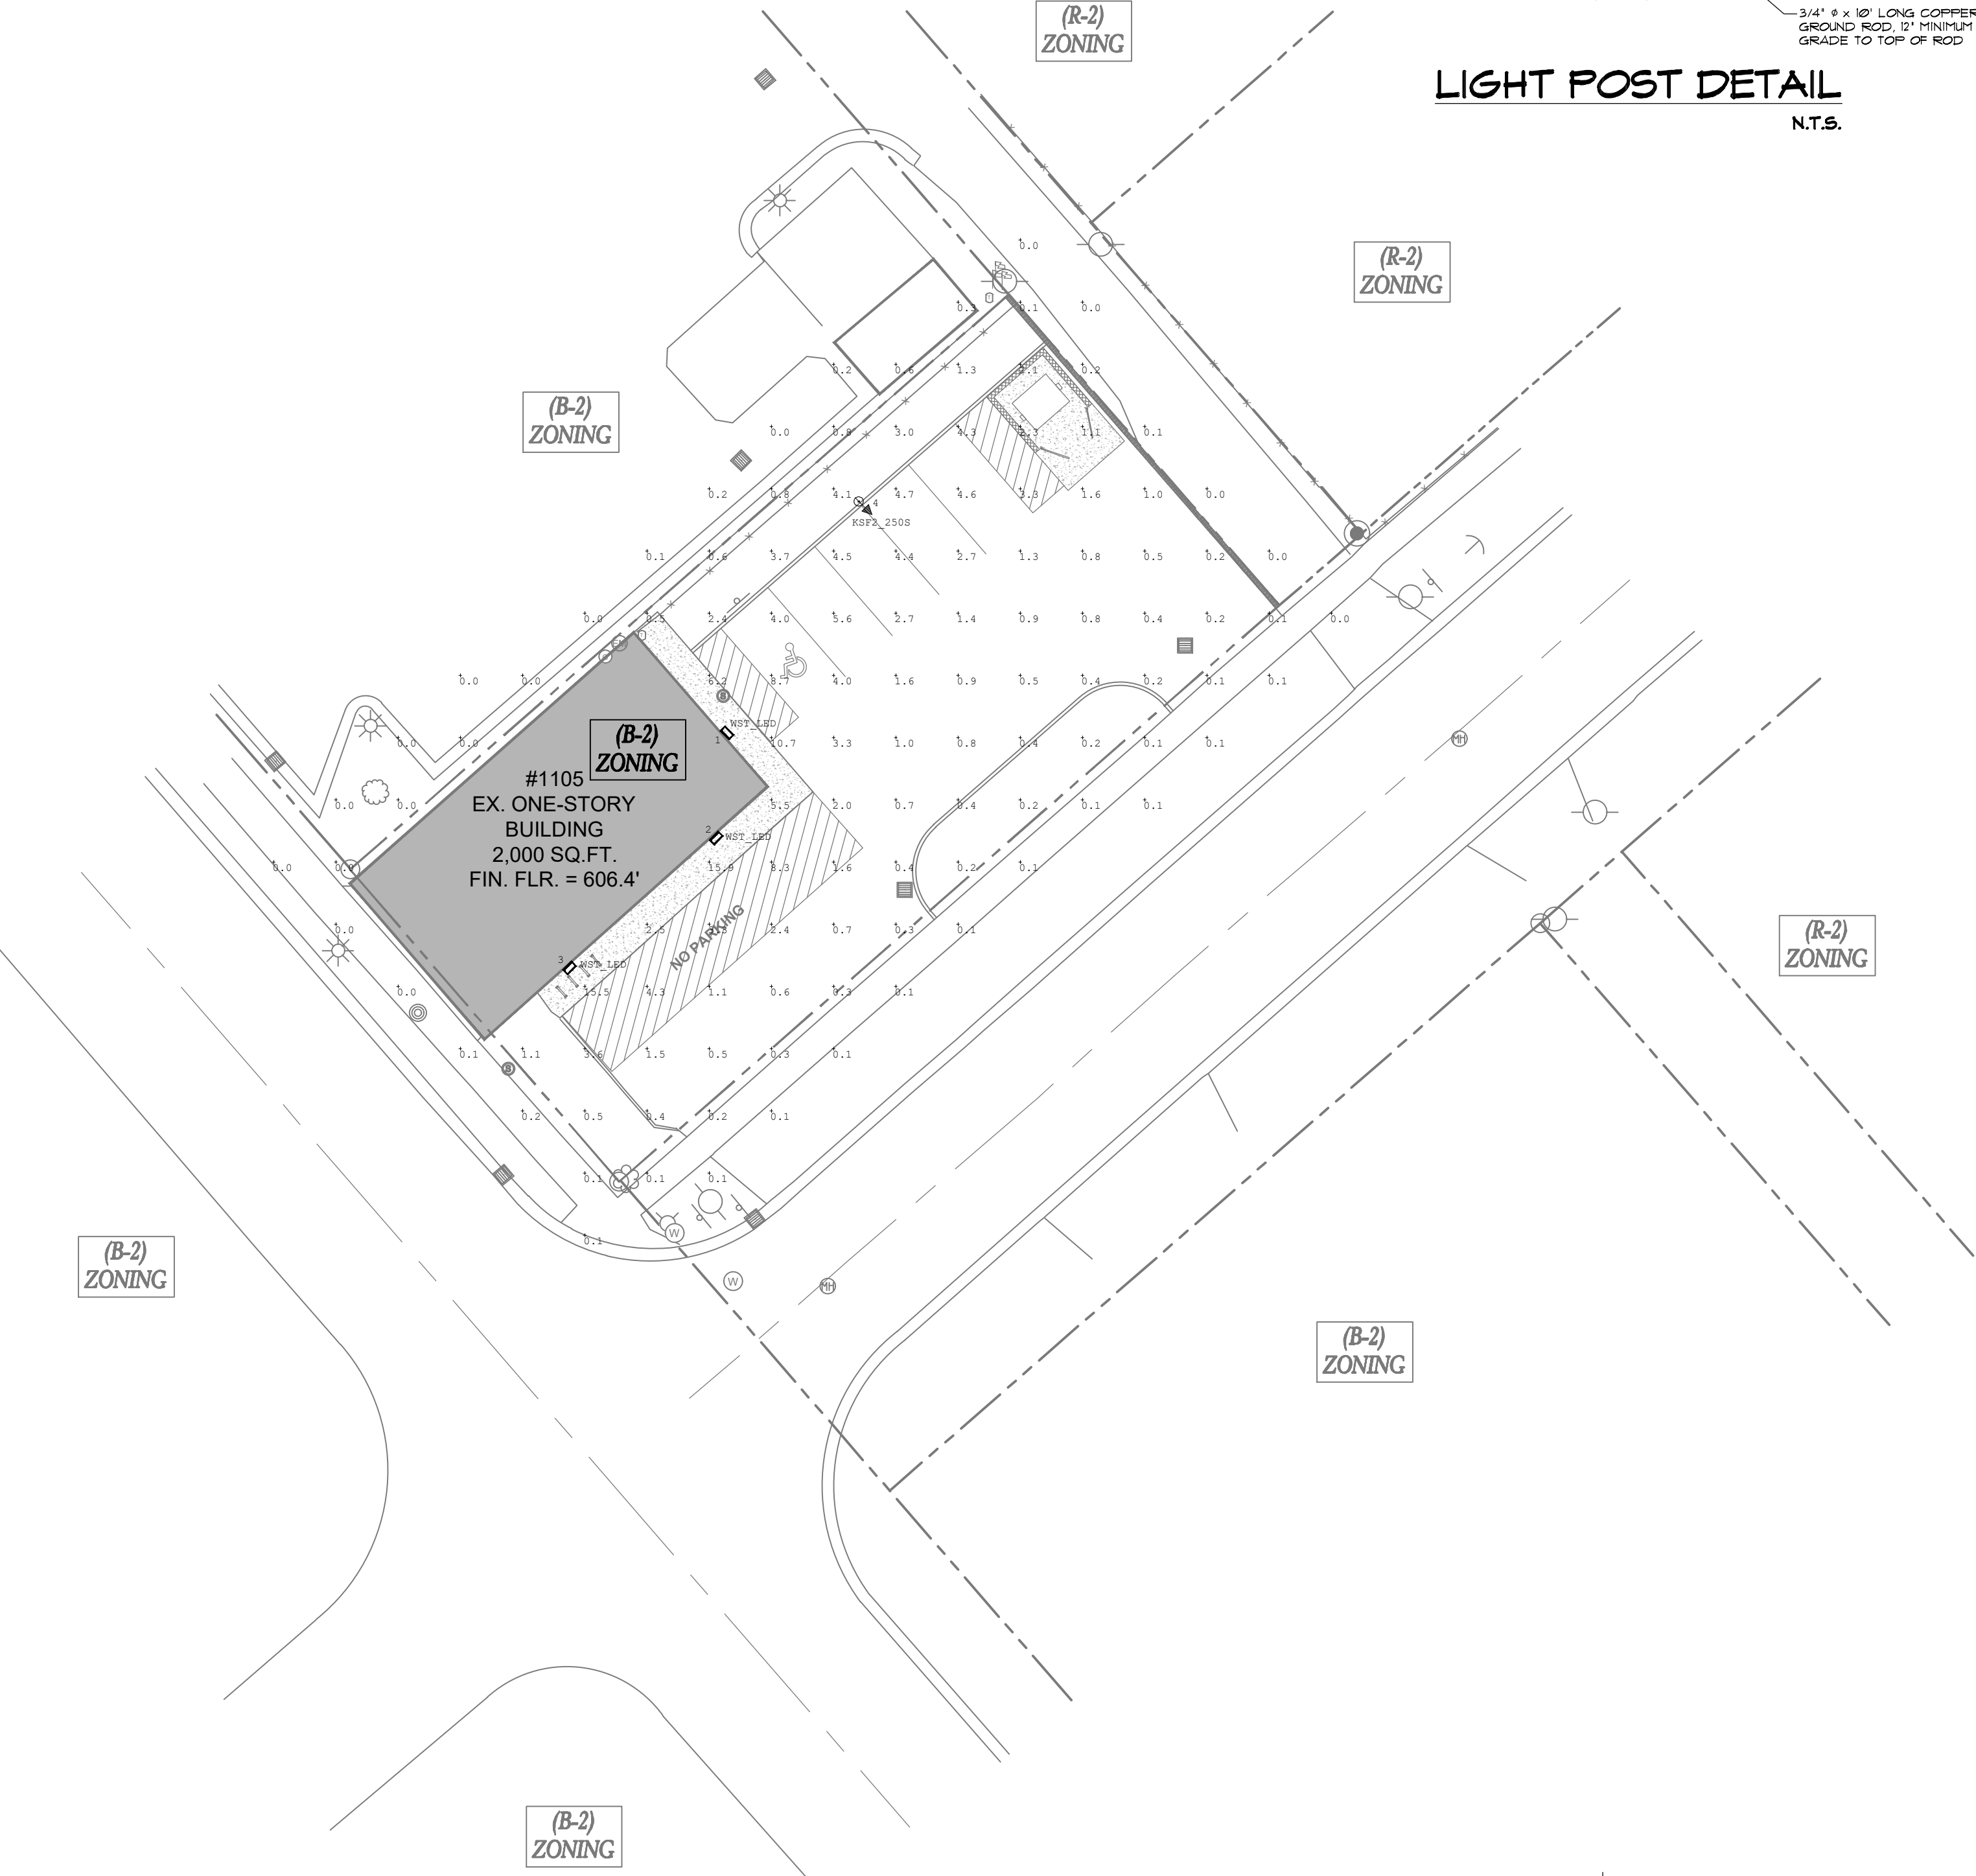

PHOTOMETRIC LIGHTING PLAN
SCALE: 1" = 20'-0"

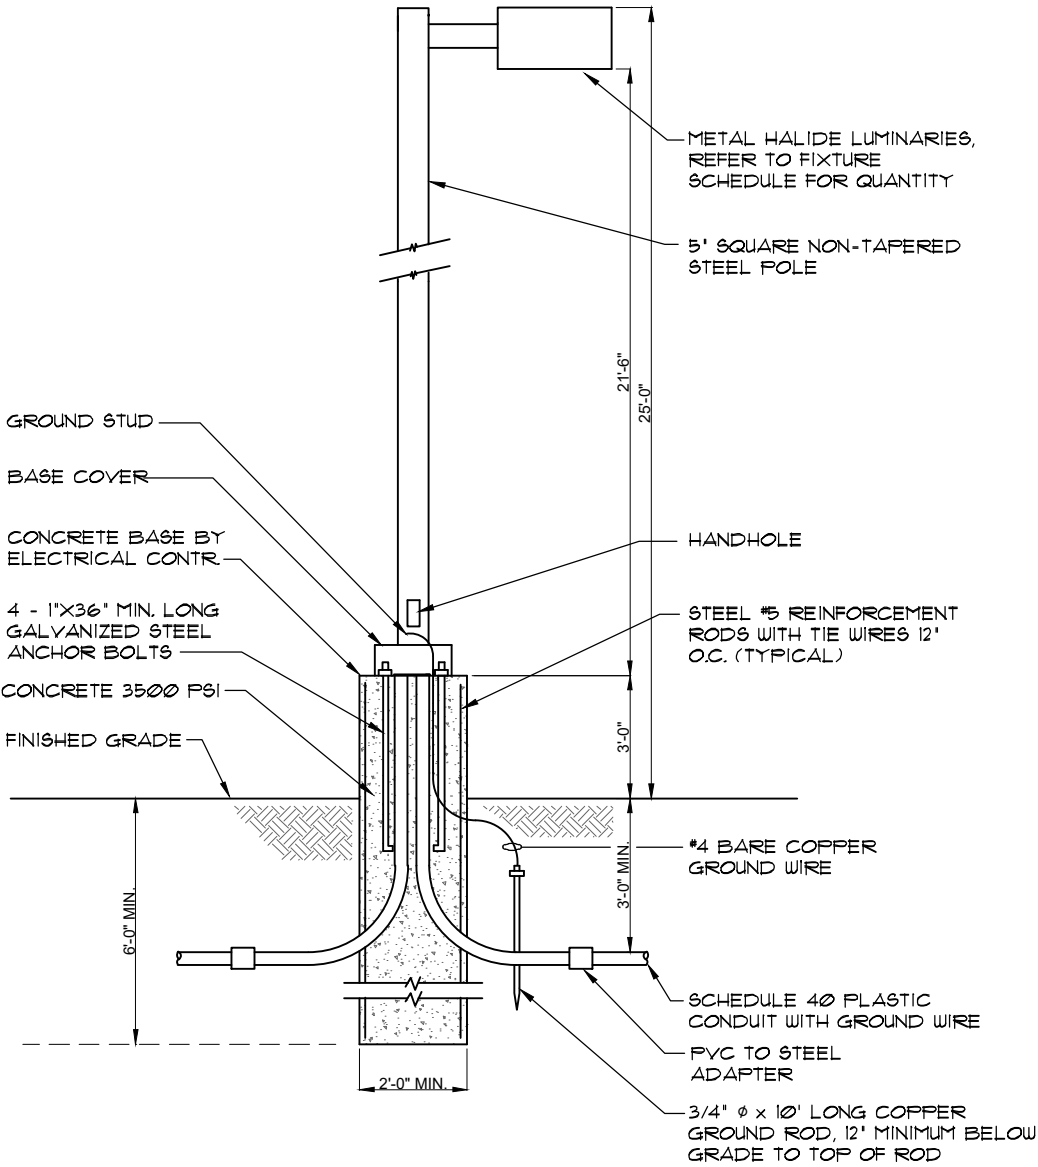

LIGHT POST DETAIL
N.T.S.



FEATURES & SPECIFICATIONS

INTENDED USE — Ideal for car lots, street lighting or parking areas.

CONSTRUCTION — Rugged, .063" thick, aluminum recilinear housing. Formed for weather-tight seal and integrity. Naturally anodized, extruded aluminum door frame with mitered corners, is retained with two .188" diameter hinge pins and secured with one quarter-turn, quick-release fastener. Weatherproof seal between housing and door frame is accomplished with an integrally designed, extruded silicone gasket that snaps into the door frame, and another gasket applied to the housing.

Finish: Standard finish is dark bronze (DOB), polyester powder finish with other architectural colors available.

OPTICS — Reflectors are anodized and segmented for superior uniformity and control. Reflectors attach with tool-less fasteners and are rotatable and interchangeable. Five cutoff distributions available: Type II (roadway), Type III (asymmetric), Type IV (forward throw, sharp cutoff), Type IV (wide, forward throw), Type V (square). Lens is .125" thick impact-resistant tempered glass with thermally applied silk-screened shield.

ELECTRICAL — Ballast: Constant wattage autotransformer for 250-400W. Super CWA (pulse start ballast), DOE 2017 compliant, is required for 250-400W (SCWA option) for U.S. shipments only. CSA or INTL required for probe-start shipments outside the U.S.

Ballasts are 100% factory-tested.

Socket is porcelain, horizontally mounted mogul base socket with copper alloy, nickel-plated screw shell and center contact. UL listed 1500W-600V.

INSTALLATION — Extruded aluminum arm for pole or wall mounting is shipped in fixture carton. Optional mountings available.

LISTING — UL listed (standard), CSA Certified (see Options), NOM Certified (see Options), UL listed for 25°C ambient temperature and wet locations. IP65 rated.


WARRANTY — 1-year limited warranty. Complete warranty terms located at:

www.acuitybrands.com/CustomersResources/terms_and_conditions.aspx

Note: Actual performance may differ as a result of end-user environment and application.

Specifications subject to change without notice.


Catalog Number
Notes
Type

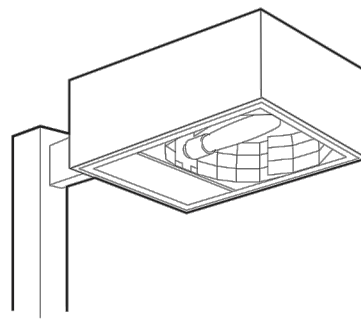

Area Lighting KSF2

METAL HALIDE: 250-400W
HIGH PRESSURE SODIUM: 200-400W
15' to 25' Mounting

Specifications	
EPA: 2.0 Ft ² (28 m ²) (includes arm)	
Length: 24-19/32 (62.5)	
Width: 17-25/32 (62.5)	
Depth: 8-5/16 (21.1)	
Arm: 4 (10.2)	
*Weight: 52 lbs (23.6 kg)	
*Weight as configured in example below.	
All dimensions are inches (centimeters) unless otherwise specified.	

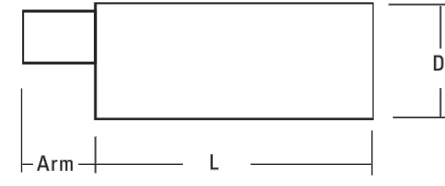

Mounting option	Drilling template
SPxx, RPxx, DA12P	5
WBxx, DA12WB	6
WWxx	7

ORDERING INFORMATION For shortest lead times, configure product using **bolded options**. **Example:** KSF2 400M R3 TB SCWA SP04 LPI

Series	Wattage	Distribution	Voltage	Ballast	Mounting
KSF2	Metal halide	R2 Type II roadway	120 347	(blank) Magnetic	Type
	250M^{1,4}	R3 Type III asymmetric	208⁴ 480⁴	CWI Constant wattage isolated ⁵	SP Square pole
	320M^{1,4}	R4SC Type IV forward throw, sharp cutoff	240 ⁴ TB ⁸	Pulse Start	RP Round pole
	High pressure sodium ¹	RAW Type IV wide, forward throw	277 23050HZ ²	SCWA Super CWA pulse-start ballast	WB Wall bracket
	200S 400S 250S	RSS Type V square		NOTE: For shipments to U.S. territories, SCWA must be specified to comply with USA.	WW Wood pole or wall bracket
					Arm length ⁷

Options	Finish ¹⁴	Lamp ¹⁵
Shipped installed in fixture	(blank) Dark bronze	DNAX Natural aluminum
PER NEMA twist-lock receptacle only (no photocontrol)	DWH White	DWHXD White
Single fuse (120, 277, 347V) n/a TB ⁸	DBL Black	DOBXD White
SF Double fuse (208, 240, 480V) n/a TB ⁸	DMB Medium bronze	DOBXD Textured dark bronze
DF Quartz restrike system ⁹	DNA Natural aluminum	DBLXD Textured black
QRS Quartz restrike system ⁹	CRT Non-stick protective coating ¹³	DNAXD Textured natural aluminum
QRSTD QRS time delay ^{4,9}	Super Durable Finishes	DNAXD Textured white
	DOBXD Dark bronze	DWHGXD Textured white
	DBLXD Black	

Accessories: Tenon Mounting Slipfitter						
Tenon O.D.	One	Two@180°	Two@90° ¹⁷	Three@120°	Three@90° ¹⁷	Four@90° ¹⁷
2-3/8" (6)	T20-190	T20-280	T20-290	T20-320	T20-390	T20-490
2-7/8" (7.3)	T25-190	T25-280	T25-290	T25-320	T25-390	T25-490
4" (10.2)	T35-190	T35-280	T35-290	T35-320	T35-390	T35-490

- Notes**
- These wattages require the REGC1 option to be chosen for shipments into California for Title 20 compliance. 250M REGC1 is not available in 347V or 480V.
 - Use reduced jacketed lamp.
 - Not available with SCWA.
 - Must specify CWI for use in Canada.
 - Optional multi-tap ballast (120, 208, 240, 277V; (120, 277, 347V in Canada).
 - Consult factory for available wattages.
 - Use 9" arm when two or more luminaires are oriented on a 90° drilling pattern.
 - Must specify voltage. Not available with TB.
 - Maximum allowable wattage lamp included.
 - KiloWatch® controls are available only with 250S or 400S.
 - May be ordered as an accessory.
 - Price with KSF2 when ordering as an accessory.
 - Available with R2 and R3 distributions only.
 - See www.lithonia.com/archcolors for additional color options.
 - Black finish only.
 - Must be specified.
 - Must use RP09 or RP12.

OUTDOOR

KSF2-M-S




WST LED Architectural Wall Sconce



Specifications


Luminaire

Height: 8-1/2" (21.59 cm)
Width: 17" (43.18 cm)
Depth: 10-3/16" (25.9 cm)
Weight: 20 lbs (9.1 kg)

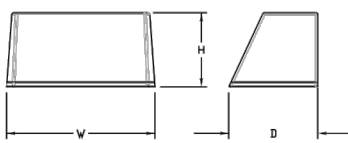

Optional Back Box (PBBW)

Height: 8.49" (21.56 cm)
Width: 17.01" (43.21 cm)
Depth: 1.70" (4.30 cm)

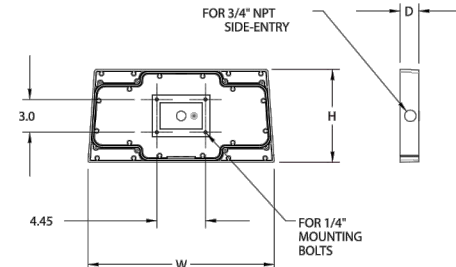

Catalog Number
Notes
Type

Use the Tab key or mouse over this page to see all interactive elements.

Capable Luminaire

This item is an A+ capable luminaire, which has been designed and tested to provide consistent color appearance and system-level interoperability.

- All configurations of this luminaire meet the Acuity Brands' specification for chromatic consistency
- This luminaire is A+ Certified when ordered with DTL® controls marked by a **shaded background**. DTL DLL equipped luminaires meet the A+ specification for luminaire to photocontrol interoperability1
- This luminaire is part of an A+ Certified solution for ROAM® or XPoint™ Wireless control networks, providing out-of-the-box control compatibility with simple commissioning, when ordered with drivers and control options marked by a **shaded background**

- To learn more about A+, visit www.acuitybrands.com/aplus.
- See ordering tree for details.
- A+ Certified Solutions for ROAM require the order of one ROAM node per luminaire. Sold Separately: [Link to Roam](#); [Link to DTL DLL](#)



Cell Phone: (313) 505-7744
Email: alahwalmoneer@gmail.com

VIVID DESIGN STUDIO

PROJECT: PROPOSED PROVISIONING CENTER

ADDRESS:
1105 W CHISHOLM ST. ALPENA, MI 49707
CLIENT'S NAME: Fadi Yousif & Mark Yousif

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REVISIONS:

_____	05/25/2022
_____	06/06/2022

DATE: 05/11/2022

DRAWN BY: MONEER ALAHWAL

SCALE: AS NOTED


SHEET TITLE:

- SITE PHOTOMETRIC LIGHTING PLAN

SHEET #:

SP-4

APPROVED BY:

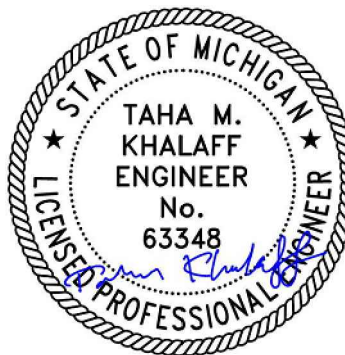


REVISIONS:	
_____	05/25/2022
_____	06/06/2022

DATE:	05/11/2022
DRAWN BY:	MONEER ALAHWAL
SCALE:	AS NOTED

SHEET TITLE:	- BUILDING'S ELEVATIONS
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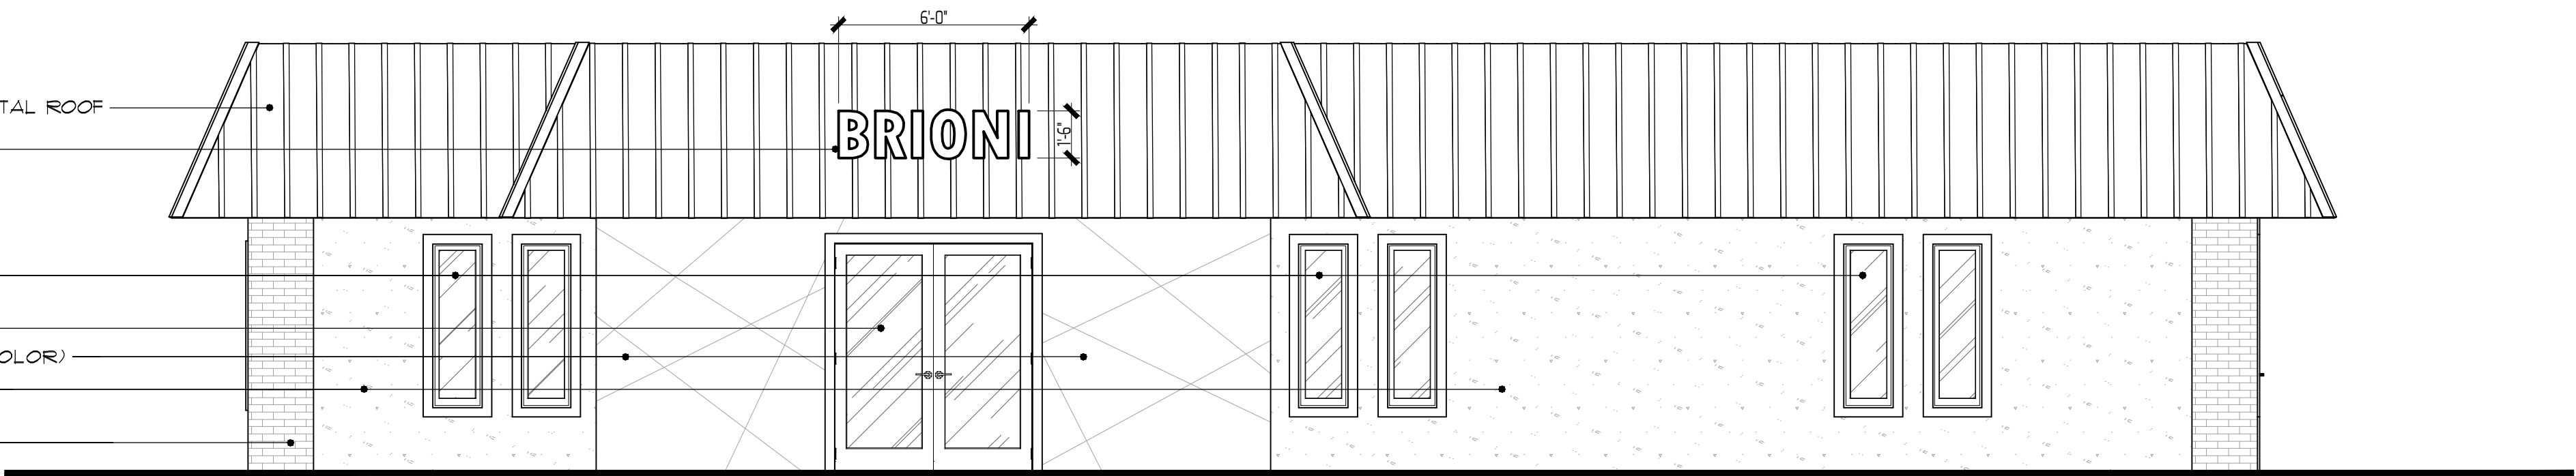
SHEET #:	A-3
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APPROVED BY:




NOTE:
THE ENTIRE EXTERIOR OF THE BUILDING WILL BE REPAINTED NEW. ANY DAMAGED AREA IN THE EXTERIOR OF THE BUILDING WILL BE REPAIRED. REFER TO THE BUILDING'S ELEVATIONS.

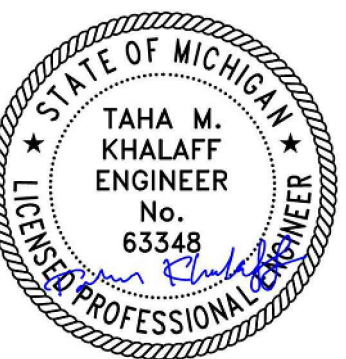EXISTING STANDING SEAM METAL ROOF
PROPOSED SIGN
EXISTING WINDOWS
W/ ALUMINUM FRAME
TEMPERED GLASS DOOR
W/ ALUMINUM FRAME
EIFS WITH GROOVES (WHITE COLOR)
EIFS (CHARCOAL COLOR)
EXISTING BRICK VENEER
(LIGHT BROWN COLOR)




FRONT ELEVATION
SCALE: 1/4" = 1'-0"

EXISTING STANDING SEAM
METAL ROOF
EXISTING WINDOWS
W/ ALUMINUM FRAME
EXISTING BRICK VENEER
(LIGHT BROWN COLOR)

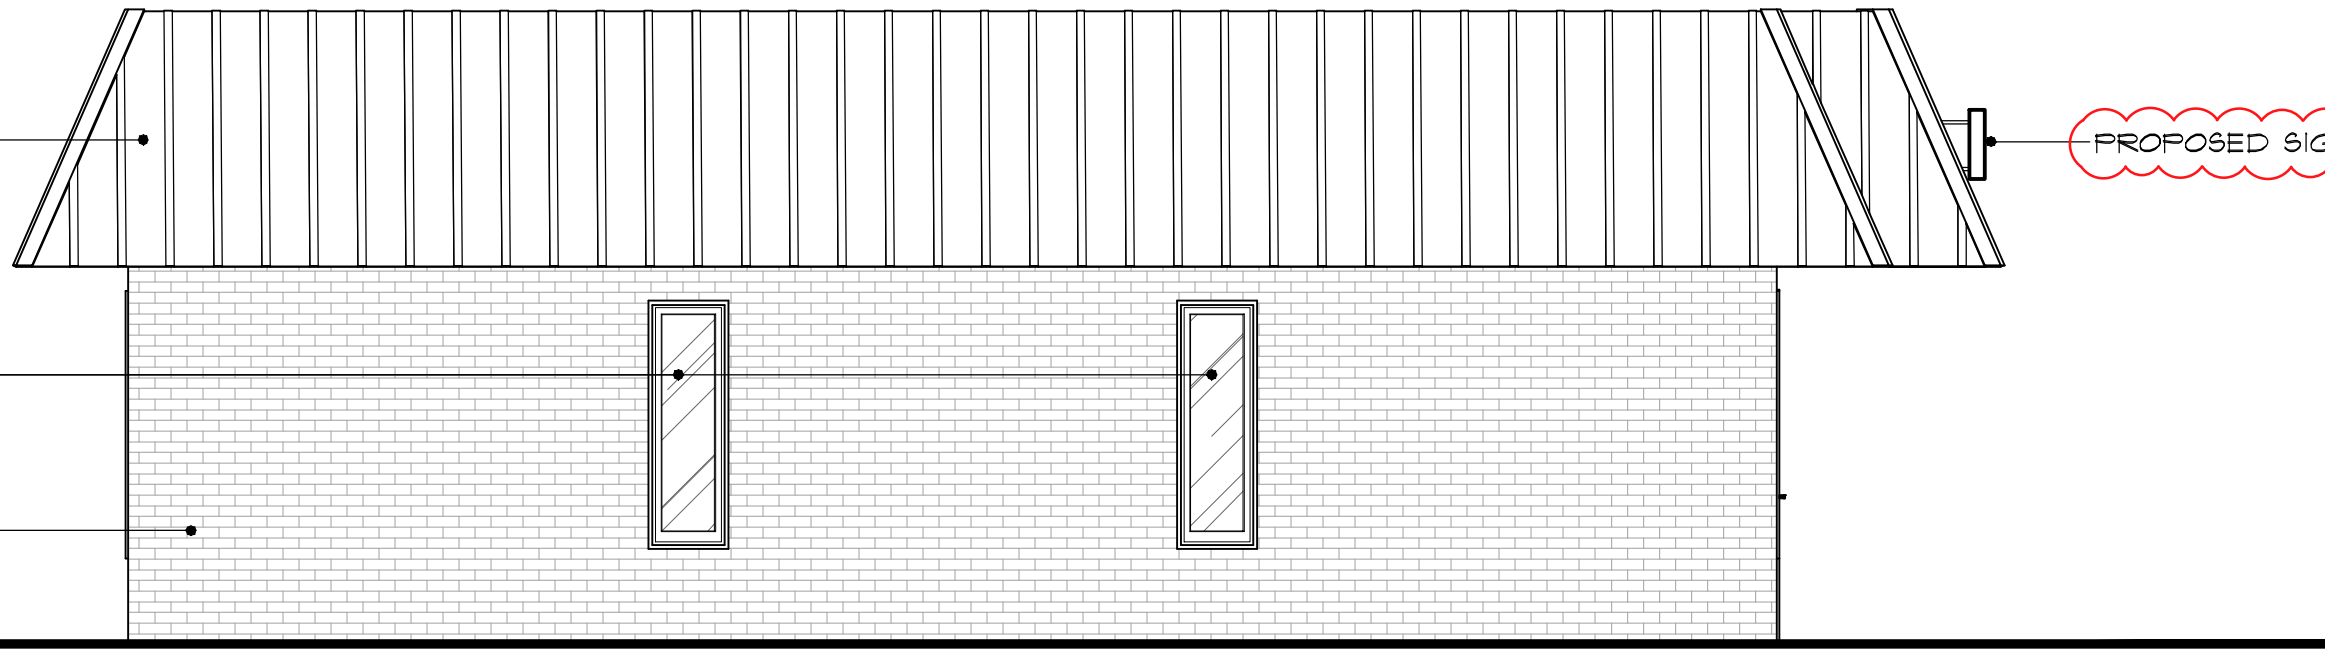


LEFT ELEVATION
SCALE: 1/4" = 1'-0"

EXISTING STANDING SEAM
METAL ROOF
PROPOSED SIGN
HOLLOW METAL DOOR
EXISTING BRICK VENEER
(LIGHT BROWN COLOR)
EIFS (BROWN COLOR)

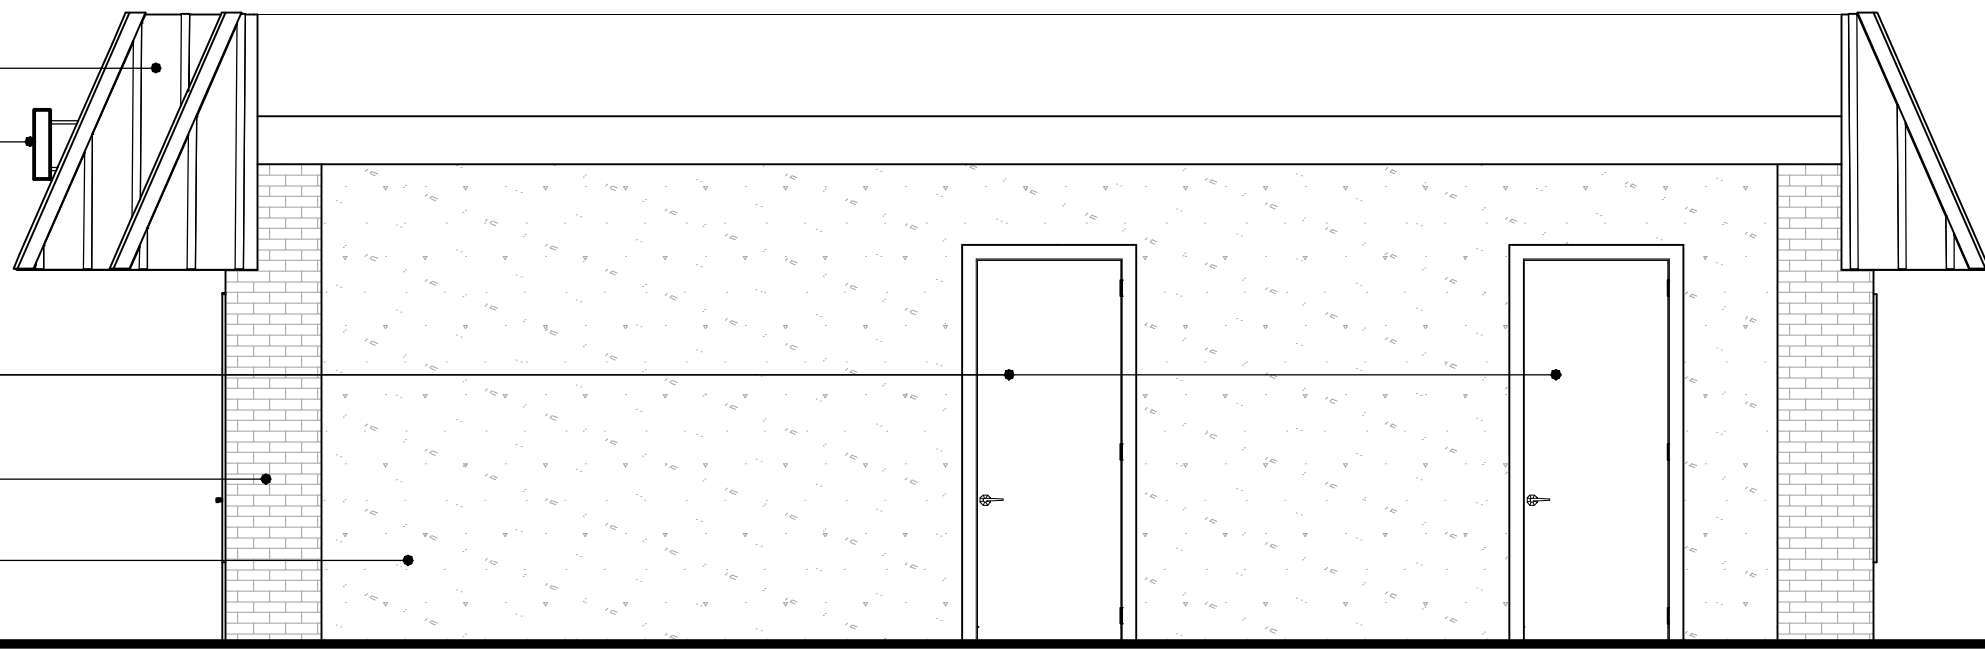

RIGHT ELEVATION
SCALE: 1/4" = 1'-0"

EXISTING STANDING SEAM
METAL ROOF
EXISTING WINDOWS
W/ ALUMINUM FRAME
EXISTING BRICK VENEER
(LIGHT BROWN COLOR)
EXISTING EIFS
(WHITE COLOR)

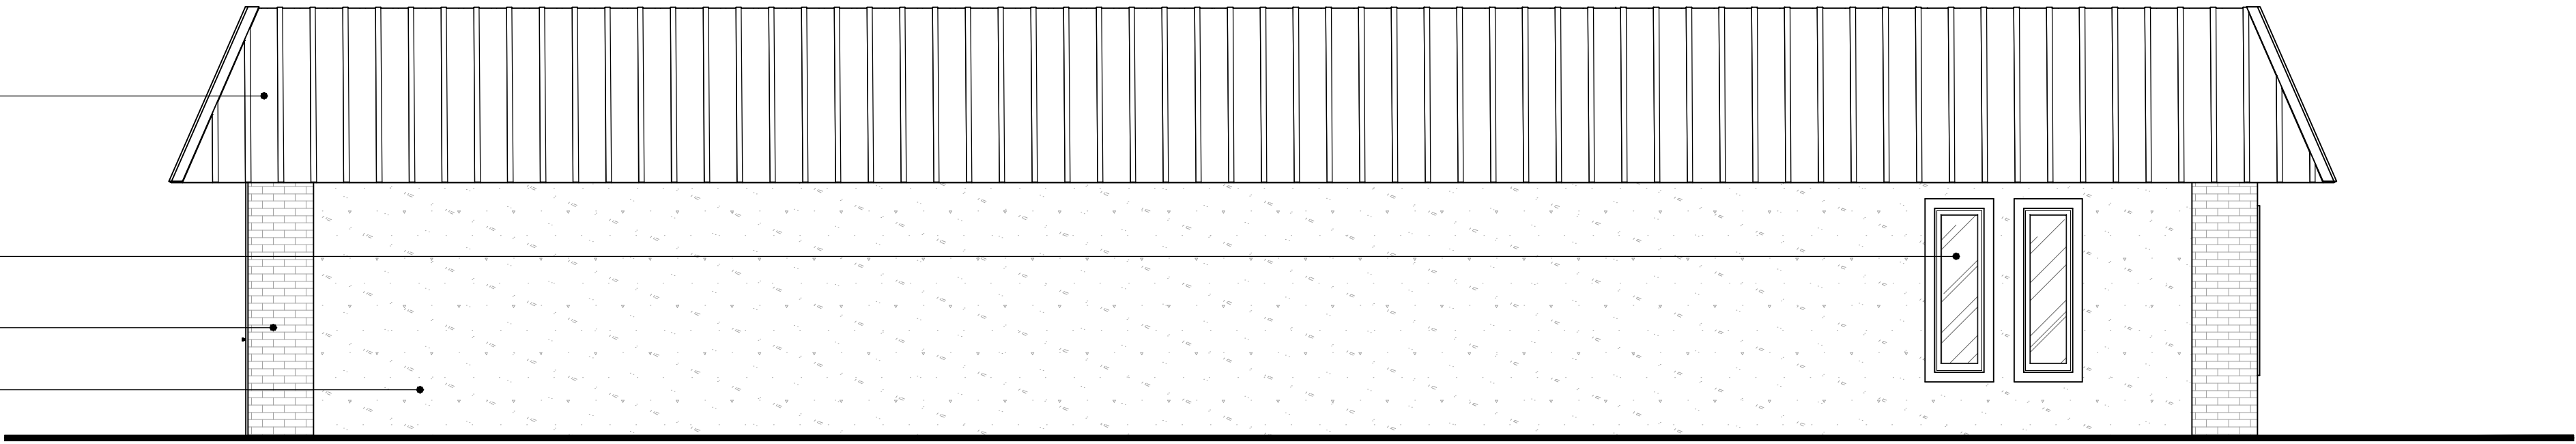

REAR ELEVATION
SCALE: 1/4" = 1'-0"

3D PERSPECTIVE MODEL
N.T.S.

